MODWASH - UPPER ALLEN TOWNSHIP, PA PRELIMINARY/FINAL LAND DEVELOPMENT PLAN

GENERAL NOTES:

- 1. THE PURPOSE OF THIS PLAN IS TO CONSTRUCT A CAR WASH LOCATED AT 127 KIM ACRES DRIVE, MECHANICSBURG, PA 17055 (TAX PARCEL NUMBER 42-29-2454-181).
- 2. BEFORE STARTING WORK, THE CONTRACTORS SHALL EXAMINE THE JOB SITE AND THE DRAWINGS AND BE THOROUGHLY FAMILIAR WITH THE ENTIRE CONSTRUCTION, THE FACILITIES, ANY DIFFICULTIES IN THE WORK TO BE COMPLETED, THE ACCURACY OF THE DRAWINGS AND DETAILS, AND QUANTITY OF LABOR AND MATERIALS REQUIRED.
- 3. CONTRACTORS SHALL NOT SCALE THESE DRAWINGS FOR CONSTRUCTION OR BIDDING PURPOSES. IN THE EVENT OF OMISSIONS OF NECESSARY DIMENSIONS OR INFORMATION, THE CONTRACTOR SHALL NOTIFY THE ARCHITECT OR ENGINEER. FIGURED AND CALCULATED DIMENSIONS TAKE PRECEDENCE OVER SCALED MEASUREMENTS. DETAILED DRAWINGS AND LARGER SCALE DRAWINGS TAKE PRECEDENCE OVER SMALLER SCALED DRAWINGS.
- 4. ALL PLAN DETAILS AND WALL SECTIONS ARE CONSIDERED "TYPICAL" INDUSTRY DETAILS UNLESS NOTED OTHERWISE AS SITE SPECIFIC.
- 5. TRAFFIC SHALL BE MAINTAINED ON ALL ADJOINING STREETS AND DRIVES AT ALL TIMES. TRAFFIC CONTROL SHALL BE MAINTAINED IN ACCORDANCE WITH PENNDOT'S REQUIREMENTS.
- 6. CONTRACTOR SHALL VERIFY THE LOCATION AND INVERT ELEVATION OF ALL EXISTING UTILITIES WITH PROPOSED CONNECTIONS PRIOR TO CONSTRUCTION AND GRADING OF THE SITE. THE ENGINEER SHALL BE IMMEDIATELY NOTIFIED OF ANY DESIGN CONFLICTS.
- SUPPLEMENTS, OF THE PENNSYLVANIA DEPARTMENT OF TRANSPORTATION SPECIFICATIONS PUB. FORM 408, UNLESS OTHERWISE NOTED.
- 8. A PENNDOT HIGHWAY OCCUPANCY PERMIT, PURSUANT TO SECTION 420 OF THE ACT OF JUNE 1, 1945 (P.L. 1242 NO. 428), KNOWN AS THE "STATE HIGHWAY LAW" IS REQUIRED FOR DRIVEWAY ACCESS TO ANY STATE ROADWAY.
- 9. A FINAL EROSION AND SEDIMENTATION CONTROL PLAN AND PERMIT PURSUANT TO THE RULES AND REGULATIONS OF THE PENNSYLVANIA DEPARTMENT OF ENVIRONMENTAL PROTECTION (TITLE 25, PART 1, SUBPART C, ARTICLE II, CHAPTER 102 OF THE PENNSYLVANIA CODE) IS REQUIRED BEFORE ANY EARTH MOVING ACTIVITIES ON THE PROPOSED LOTS IS ALLOWED.
- 10. ALL PROPOSED ACCESSIBLE FACILITIES ARE TO BE CONSTRUCTED TO CURRENT ADA REQUIREMENTS AND STANDARDS.
- 11. ALL PROPOSED ON-SITE LIGHTING SHALL BE DIRECTED INWARD AND DOWNWARD AWAY FROM RESIDENTIAL PROPERTIES AND ALL STREET
- 12. LAND DEVELOPMENT PLAN APPROVAL DOES NOT RELIEVE THE OWNER FROM ALL APPLICABLE SIGN REGULATIONS. ALL PROPOSED ON-SITE SIGNAGE SHALL CONFORM TO THE MUNICIPAL ZONING ORDINANCES. ALL SIGNAGE MUST COMPLY WITH CHAPTER 245, ARTICLE XVIII OF THE
- 13. CONTRACTOR IS RESPONSIBLE FOR VERIFYING QUANTITIES, INCLUDING EARTHWORK. IT IS THE RESPONSIBILITY OF THE CONTRACTOR TO NOTIFY THE OWNER AND ENGINEER DURING THE BIDDING PROCESS OF ANY QUANTITY DISCREPANCIES IN THE BID DOCUMENTS. ONCE THE CONSTRUCTION CONTRACT IS ISSUED, THE CONTRACTOR ACKNOWLEDGES THE CONTRACT PRICE COVERS ALL LABOR, MATERIALS AND INCIDENTALS TO SUBSTANTIALLY COMPLETE THE PROJECT ACCORDING TO THE CONSTRUCTION PLANS.
- 14. IT IS THE INTENTION OF THE ENGINEER THAT THE DRAWINGS AND SPECIFICATIONS PROVIDE FOR A COMPLETELY FINISHED PROJECT. ANYTHING OR MATTER SHOWN ON THE DRAWINGS OR DESCRIBED BY THE SPECIFICATIONS OR FAIRLY IMPLIED BY EITHER OR BOTH, SHALL BE CONSIDERED A PART OF THE WORK THE SAME AS IF NOTED, SHOWN AND DESCRIBED. SHOULD THE CONTRACTORS FIND ANY DISCREPANCIES OR OMISSIONS IN THE DRAWINGS OR SPECIFICATIONS, OR BE IN DOUBT AS TO THEIR MEANING, THEY SHALL NOTIFY THE ENGINEER PRIOR TO PROCEEDING WITH THE WORK. ANY CLARIFICATIONS FROM THE ENGINEER WILL BE WRITTEN AND THE CONTRACTORS SHALL BE RESPONSIBLE AT NO COST TO THE OWNER OR ENGINEER FOR ANY WORK WHICH MUST BE REDONE BECAUSE OF THEIR FAILURE TO COMPLY WITH THE PRECEDING.
- 15. FURTHER EXPLANATORY DRAWINGS OR DETAILS WILL ALSO BE CONSIDERED PART OF THE PROJECT AND WORK EXECUTED WITHOUT SUCH DETAILS SHALL BE AT THE CONTRACTOR'S RISK.
- 16. THE CONTRACTOR SHALL VERIFY AND BE RESPONSIBLE FOR ALL DIMENSIONS AND MEASUREMENTS. ANY DISCREPANCIES BETWEEN THE DRAWING AND ACTUAL EXISTING CONDITIONS SHALL BE REPORTED TO THE ENGINEER BEFORE PROCEEDING. ANY CHANGES OR CORRECTIONS WILL BE WRITTEN, AND THE CONTRACTORS SHALL BE RESPONSIBLE FOR ANY WORK COMPLETED BEFORE RECEIVING SAID
- 17. IN THE CASE OF AN INCONSISTENCY BETWEEN DRAWINGS AND SPECIFICATIONS, OR WITHIN EITHER DOCUMENT NOT CLARIFIED BY AN ADDENDUM, THE BETTER QUALITY OR GREATER QUANTITY OF WORK SHALL BE PROVIDED IN ACCORDANCE WITH THE ENGINEER AND THE OWNER'S REPRESENTATIVES INTERPRETATION.
- 18. THE CONTRACTOR SCHEDULE A PRE-CONSTRUCTION SITE MEETING WITH THE UPPER ALLEN TOWNSHIP ENGINEER AND THE CUMBERLAND COUNTY CONSERVATION DISTRICT AT LEAST 48 HOURS PRIOR TO STARTING SITE CONSTRUCTION ACTIVITIES.
- 19. ALL WORK WITHIN THE PUBLIC STREET RIGHT-OF-WAY AND WORK RELATED TO STORM DRAINAGE AND SANITARY SEWER FACILITIES REQUIRES INSPECTION BY THE TOWNSHIP. PROVIDE A MINIMUM 48 HOURS NOTICE TO THE TOWNSHIP BEFORE STARTING WORK.
- 20. AS-BUILT MYLAR PLANS AND ELECTRONIC DATA FILES SHALL BE PROVIDED TO THE TOWNSHIP. ALL DRAWINGS MUST BE SIGNED AND SEALED BY A PROFESSIONAL ENGINEER OR LAND SURVEYOR ATTESTING TO THE CORRECTNESS OF THE FACILITY INFORMATION SHOWN, IN ACCORDANCE WITH SECTION 220-4.2.C(3) OF THE CODIFIED ORDINANCES OF THE TOWNSHIP.
- 21. NOTHING SHALL BE PLACED, PLANTED, SET OR PUT WITHIN THE AREA OF AN EASEMENT OR PLANTING STRIP THAT WOULD ADVERSELY AFFECT THE FUNCTION OF THE EASEMENT OR PLANTING STRIP OR CONFLICT WITH AN EASEMENT AGREEMENT. NO STRUCTURES SHALL BE PLACED IN ANY EASEMENT OR PLANTING STRIP UNLESS OTHERWISE NOTED IN AN AGREEMENT.

UTILITY COMPANIES

100 GETTYSBURG PIKE MECHANICSBURG, PA. 17055

SANITARY

KODI HOCKENBERRY khockenberry@uatwp.org SUEZ WATER

UPPER ALLEN TOWNSHIP

NAT SHEFFER

PENNSYLVANIA INC.

6310 ALLENTOWN BLVD

HARRISBURG, PA. 17112

nathaniel.sheffer@suez.com

ELECTRICITY SUEZ WATER PENNSYLVANIA INC. 6310 ALLENTOWN BLVD HARRISBURG, PA. 17112 NAT SHEFFER nathaniel.sheffer@suez.com <u>CABLE</u>

UGI UTL LANCASTER

STEPHEN BATEMAN

sbateman@ugi.com

MIDDLETOWN, PA. 17057

TELEPHONE/FIBER OPTICS

VERIZON PENNSYLVANIA LLC

PITTSBURGH, PA. 15221

deborah.d.delia@verizon.com

1301 AIP DRIVE

1026 HAY ST

DEBORAH BARUM

COMCAST 4601 SMITH STREET HARRISBURG, PA. 17109 MICHAEL SWEIGARD mike_sweigard@cable.comcast.com

CALL BEFORE YOU DIG IN PENNSYLVANIA 1-800-242-1776 DESIGN SN: 20211762062

Know what's below Call before you dig

THE GENERAL CONTRACTOR SHALL NOTIFY ALL UTILITY COMPANIES INVOLVED IN THE SITE NO MORE TEN DAYS AND NO LESS THAN THREE DAYS IN ADVANCE OF EXCAVATION (PA ACT 287 OF 1974 AMENDED BY ACT 50 OF 2018). PA STATE LAW REQUIRES 3 WORKING DAYS NOTICE

WE, HUTTON MECHANICSBURG PA ST, LLC, THE UNDERSIGNED, OWNERS OF THE REAL ESTATE SHOWN AND DESCRIBED HEREIN, DO HEREBY CERTIFY THAT WE HAVE LAID OFF, PLATTED AND SUBDIVIDED, AND HEREBY LAY OFF, PLAN AND SUBDIVIDE, SAID REAL ESTATE IN ACCORDANCE WITH THE WITHIN PLAN. BUILDING SETBACK LINES ARE HEREBY ESTABLISHED AS SHOWN ON THIS PLAN, BETWEEN WHICH LINES AND THE PROPERTY LINES OF THE STREET THERE SHALL BE ERECTED OR MAINTAINED NO BUILDING OR STRUCTURE. THERE ARE STRIPS OF GROUND WITH VARYING WIDTH AS SHOWN ON THIS PLAN AND MARKED: "EASEMENT, RESERVED FOR THE USE OF PUBLIC UTILITIES FOR THE INSTALLATION OF WATER AND SEWER MAINS, POLES, DUCTS, LINES AND WIRES, SUBJECT AT ALL TIMES TO THE PROPER AUTHORITIES AND TO THE EASEMENT HEREIN RESERVED." NO BUILDINGS OR OTHER STRUCTURES ARE TO BE ERECTED OR MAINTAINED UPON SAID STRIPS OF LAND, BUT OWNERS OF LOTS IN THIS SUBDIVISION SHALL TAKE THEIR TITLES SUBJECT TO THE RIGHTS OF THE UTILITIES. THE FOREGOING COVENANTS (OR RESTRICTIONS) ARE TO RUN WITH THE LAND AND SHALL BE BINDING ON ALL PARTIES AND ALL PERSONS CLAIMING UNDER THEM UNTIL JANUARY 1, 2027 (A TWENTY-FIVE-YEAR PERIOD IS SUGGESTED), AT WHICH TIME SAID COVENANTS (OR RESTRICTIONS) SHALL BE AUTOMATICALLY EXTENDED FOR SUCCESSIVE PERIODS OF 10 YEARS AND SHALL REMAIN IN FULL FORCE AND EFFECT UNLESS CHANGED AT THE END OF SUCH PERIOD OF 10 YEARS BY VOTE OF A MAJORITY OF THE THEN OWNERS OF THE BUILDING SITES COVERED BY THESE COVENANTS (OR RESTRICTIONS). § 220-3.8 § 220-3.8 :2 THE RIGHT TO ENFORCE THESE PROVISIONS BY INJUNCTION, TOGETHER WITH THE RIGHT TO CAUSE THE REMOVAL, BY DUE PROCESS OF LAW, OF ANY STRUCTURE OR PART THEREOF ERECTED OR MAINTAINED IN VIOLATION HEREOF, IS HEREBY DEDICATED TO THE PUBLIC AND RESERVED TO THE SEVERAL OWNERS OF THE SEVERAL LOTS IN THIS SUBDIVISION AND TO THEIR HEIRS AND ASSIGNS.

WITNESS OUR HANDS AND SEALS THIS _____ DAY OF . 20 ___. COMMONWEALTH OF PENNSYLVANIA: :SS COUNTY OF CUMBERLAND: ON

THE UNDERSIGNED OFFICER, PERSONALLY CAME , KNOWN TO ME (OR SATISFACTORILY PROVEN) TO BE THE PERSON WHOSE NAME IS SUBSCRIBED TO THE WITHIN INSTRUMENT, AND ACKNOWLEDGED THAT _____ EXECUTED THE SAME FOR THE PURPOSES THEREIN CONTAINED. IN WITNESS WHEREOF, I HAVE HEREUNTO SET MY HAND AND


NOTARY PUBLIC MY COMMISSION EXPIRES:

THE ENGINEER ASSUMES NO RESPONSIBILITY FOR ANY CHANGES IN DESIGN PLANS UNLESS WRITTEN CONSENT IS GIVEN BY THE ENGINEER. THE CONTRACTOR AND/OR THE OWNER WILL BE HELD RESPONSIBLE FOR ANY FIELD MODIFICATIONS MADE WITHOUT THE WRITTEN CONSENT OF THE ENGINEER AND NECESSARY APPROVALS BY PERMITTING AGENCIES.

THE LOCATION OF EXISTING UTILITIES WERE TAKEN FROM RECORDS AND MARKING PROVIDED BY OTHERS AND OBSERVED EVIDENCE. THE LOCATIONS SHOWN MAY BE APPROXIMATE. THE CONTRACTOR IS RESPONSIBLE FOR DETERMINING THE EXACT LOCATIONS, SIZES AND DEPTH OF ALL UTILITIES PRIOR TO CONSTRUCTION. THE CONTRACTOR SHALL EXERCISE CARE TO AVOID DAMAGE TO ALL EXISTING UTILITIES.

2021 MORRIS KNOWLES & ASSOCIATES, INC. (A HAMMONTREE COMPANY) — THESE DRAWINGS SHALL NOT BE USED BY ANY PERSON, FIRM OR CORPORATION WITHOUT SPECIFIC WRITTEN PERMISSION FROM MORRIS KNOWLES & ASSOCIATES, INC. THESE PLANS ARE NOT TO BE REPRODUCED, CHANGED OR MANIPULATED IN ANY FORM OR MANNER WHATSOEVER, NOR ARE THEY TO BE ASSIGNED TO ANY THIRD PARTY WITHOUT PERMISSION AND CONSENT OF MORRIS KNOWLES & ASSOCIATES, INC.

127 KIM ACRES DRIVE, MECHANICSBURG, PA 17055 UPPER ALLEN TOWNSHIP, CUMBERLAND COUNTY, PA JANUARY 5, 2022

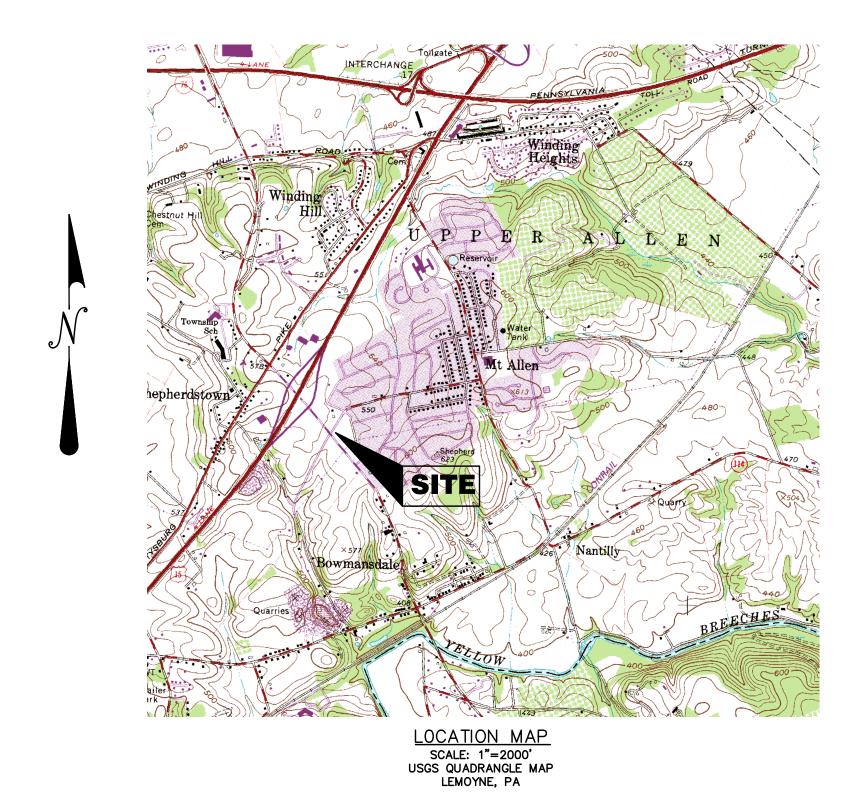

PREPARED FOR:

HUTTON MECHANICSBURG PA ST, LLC

736 CHERRY ST CHATTANOOGA, TN 37402 ATTN - ALEJANDRO QUINTANA PHONE - 404-805-0797

PREPARED BY:



Morris Knowles & Associates, Inc.

Consulting Engineers & Land Surveyors 443 ATHENA DRIVE DELMONT, PA 15626

TELEPHONE: (724) 468-4622 FAX: (724) 468-8940

(SEAL)

SURVEYOR IN COMPLIANCE WITH THE LAWS OF OF THE COMMONWEALTH OF PENNSYLVANIA; THAT THIS PLAN CORRECTLY REPRESENTS A SURVEY COMPLETED BY ME ON JULY 23, 2021; THAT ALL THE MONUMENTS SHOWN THEREON ACTUALLY EXIST; AND THAT THEIR LOCATION, SIZE, TYPE AND MATERIAL ARE ACCURATELY SHOWN.

INDEX OF SHEETS

C100
6200
C200
C201
C202
C300
C301
C302
C400
C500
C600
C601
C602
C700
C701
C702
C800
C801

ADDITIONAL SHEETS

CITE LICHTING DIAM

SITE LIGHTING PLAN	
CONDITIONALLY APPROVED BY THE BOARD OF COMMISSIONERS OF UPPER ALLEN TOWNSHIP, THIS DAY OF, 20 THE CONDITIONS OF APPROVAL WERE SATISFIED THIS DAY OF DAY OF	
(SEAL)	
ATTEST: SECRETARY PRESIDENT	
APPROVED BY THE BOARD OF COMMISSIONERS OF UPPER ALLEN TOWNSHIP, THIS, 20	
(SEAL)	
ATTEST: PRESIDENT	
REVIEWED BY THE PLANNING COMMISSION OF UPPER ALLEN TOWNSHIP, THIS DAY OF, 20	
(SEAL)	
ATTEST:	
REVIEWED BY THE CUMBERLAND COUNTY PLANNING DEPARTMENT, THIS DAY OF, 20	
ATTEST: DIRECTOR OF PLANNING	
I, ELIZABETH M. CLAWSON, ON THIS DATE JANUARY 4, 2022, HAVE REVIEWED AND HEREBY CERTIFY THAT THE SWM SITE PLAN MEETS ALL DESIGN STANDARDS AND CRITERIA OF THE UPPER ALLEN TOWNSHIP STORMWATER MANAGEMENT ORDINANCE.	
ATTEST:	



SHEET NO.

SCALE:

N/A

C000

1. THE SUBJECT PROPERTIES ARE NOT LOCATED WITHIN A 100 YEAR FLOOD PLAIN ACCORDING TO FEMA FLOOD MAP NUMBER 42041C0286E, LAST REVISED MARCH 16, 2009.

DEMOLITION NOTES:


- 1. THE CONTRACTOR IS RESPONSIBLE FOR OBTAINING ALL PERMITS REQUIRED FOR DEMOLITION WORK.
- 2. THE CONTRACTOR SHALL VERIFY THE LOCATION OF ALL UTILITY CONNECTIONS PRIOR TO CONSTRUCTION/DEMOLITION AT THIS SITE. THE CONTRACTOR SHALL ALSO COORDINATE ALL UTILITY CONNECTIONS WITH LOCAL PROVIDERS.
- 3. ALL EXISTING PAVEMENT, CURB AND SIDEWALK TO BE REMOVED SHALL BE SAW CUT AS SHOWN ON
- 4. CONTRACTOR IS RESPONSIBLE FOR REMOVAL OF ALL DRIVES, WALKS, EXISTING PAVEMENT AND CURBING WITHIN THE LIMITS AS SHOWN. ALL DEBRIS IS TO BE HAULED OFF-SITE TO AN APPROVED
- 5. CONTRACTOR SHALL BE RESPONSIBLE FOR ANY DAMAGE TO THE ROADWAYS AND ASSOCIATED STRUCTURES AND SHALL MAKE REPAIRS AS NECESSARY TO THE SATISFACTION OF THE MUNICIPALITY OF UPPER ALLEN TOWNSHIP. THE CONTRACTOR SHALL ALSO BE RESPONSIBLE FOR THE INSTALLATION AND MAINTENANCE OF ADEQUATE SIGNS AND WARNING DEVICES TO INFORM AND PROTECT THE PUBLIC. THE CONTRACTOR SHALL BE RESPONSIBLE FOR THE MAINTENANCE OF TRAFFIC THROUGH THE CONSTRUCTION PERIOD.

SOIL MAP UNIT LEGEND					
MAP UNIT SYMBOL	MAP UNIT NAME	PERCENT WITHIN LOD			
BdB	BEDINGTON SHALY SILT LOAM, 3 TO 8 PERCENT SLOPES	100			



CALL BEFORE YOU DIG IN PENNSYLVANIA 1-800-242-1776 DESIGN SN: 20211762062

Know what's below Call before you dig

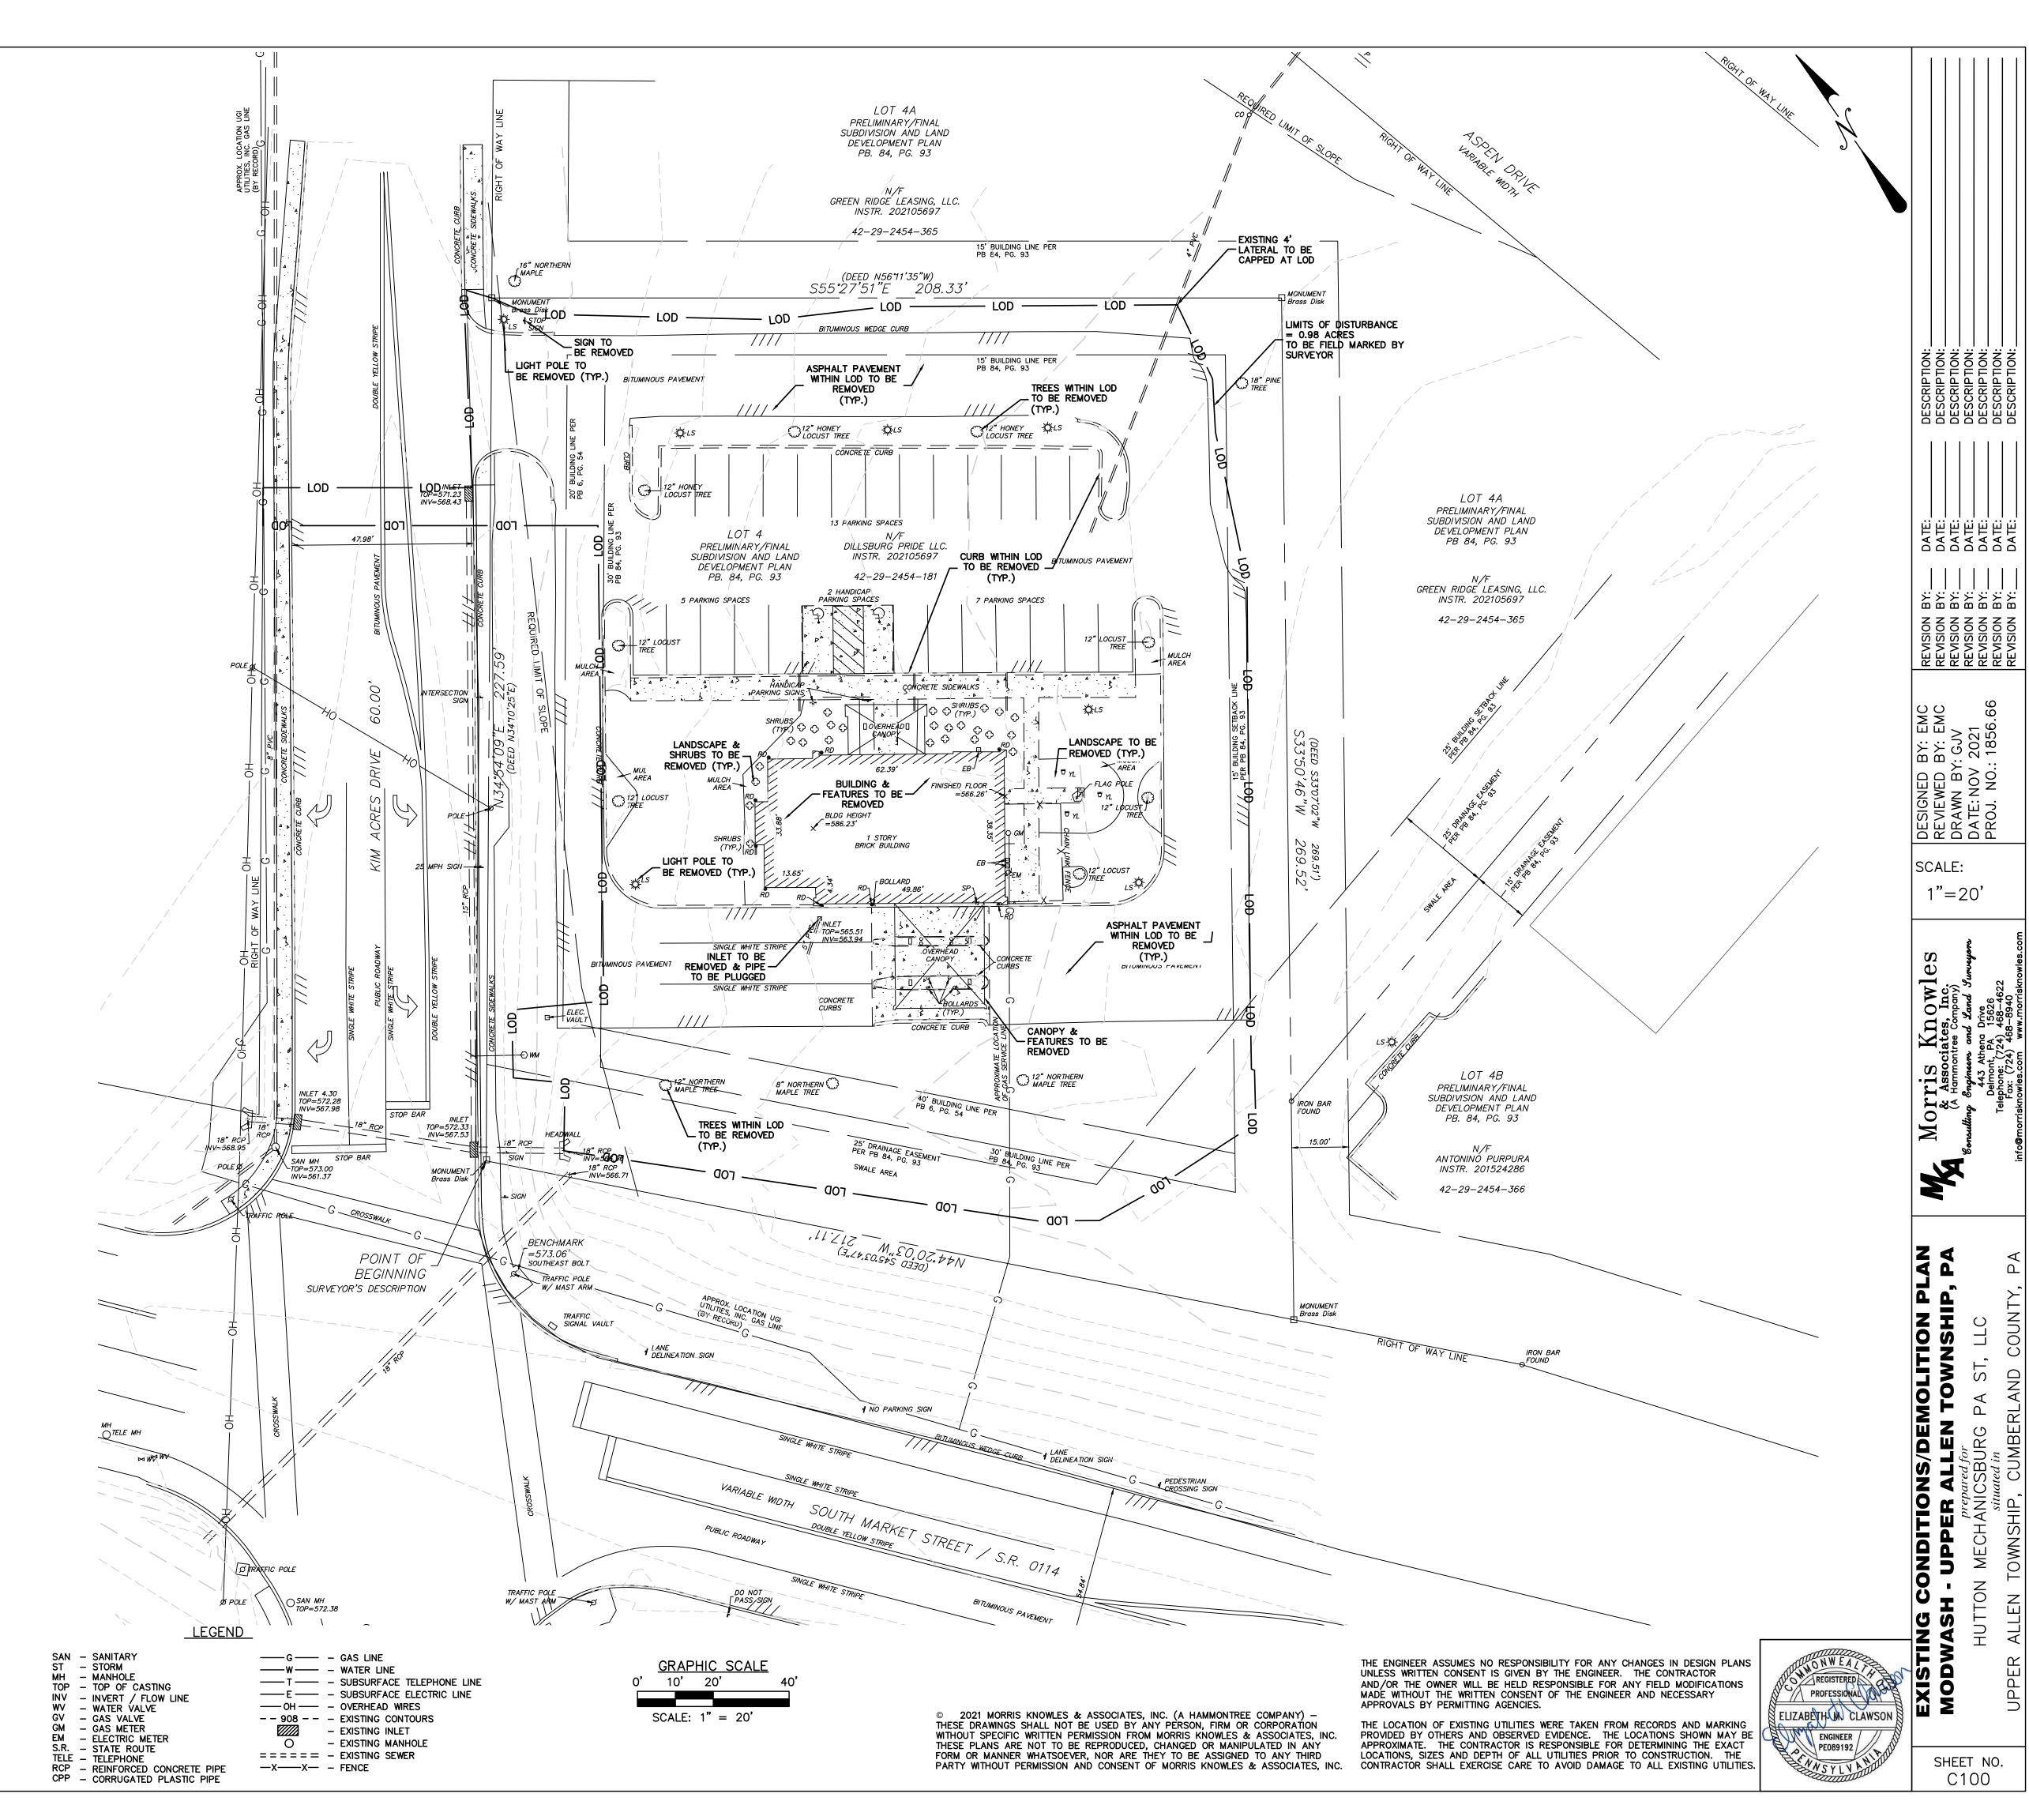

- 1. THE CONTRACTOR SHALL INSTALL ALL PAVEMENT MARKINGS AS SHOWN ON THE PLANS.
- NO WETLANDS EXIST WITHIN THE PROJECT BOUNDARY.
 MINE OPENINGS ARE NOT ANTICIPATED. IF MINE SPOILS ARE ENCOUNTERED DURING CONSTRUCTION, THE CONTRACTOR SHALL EITHER REWORK THE MATERIAL PER GEOTECHNICAL ENGINEERS RECOMMENDATIONS OR REMOVE
- THE MATERIAL TO A PERMITTED AREA.

 4. NO SIGNIFICANT CULTURAL OR SENSITIVE ENVIRONEMENTAL FEATURES EXIST WITHIN THE PROJECT BOUNDARY. NO
- FURTHER ENVIRONMENTAL STUDIES WILL BE NECESSARY.

 5. NO WATER RESOURCES EXIST WITHIN THE PROJECT BOUNDARY.

ZONING INFORMATION


LOCATION: 127 KIM ACRES DRIVE, MECHANICSBURG, PA						
ZONE: C-2 HIGHWAY COMMERCI	ZONE: C-2 HIGHWAY COMMERCIAL					
USE: CAR WASH	USE: CAR WASH					
ITEM	REQUIREMENTS	PROPOSED				
MINIMUM LOT AREA	N/A					
MINIMUM LOT WIDTH	N/A					
MINIMUM FRONT SETBACK	50 FEET	50 FEET				
MINIMUM SIDE SETBACK	25 FEET	25 FEET				
MINIMUM REAR SETBACK	25 FEET	25 FEET				
MINIMUM DRIVE AISLE SETBACK	10 FEET	10 FEET				
MAXIMUM BUILDING HEIGHT	35 FEET	<35 FEET				
MAXIMUM BUILDING COVERAGE	50 PERCENT	<50 PERCENT				
MAXIMUM SITE COVERAGE	70 PERCENT	<70 PERCENT				
LOT ACREAGE		1.20				

PARKING INFORMATION


REQUIREMENT DESCRIPTION: VEHICLE WASHING USE SHALL PROVIDE 3 PARKING SPACES FOR EACH WASH BAY.

ITEM REQUIREMENTS PROPOSED

PARKING SPACES: 3/BAY=3 24

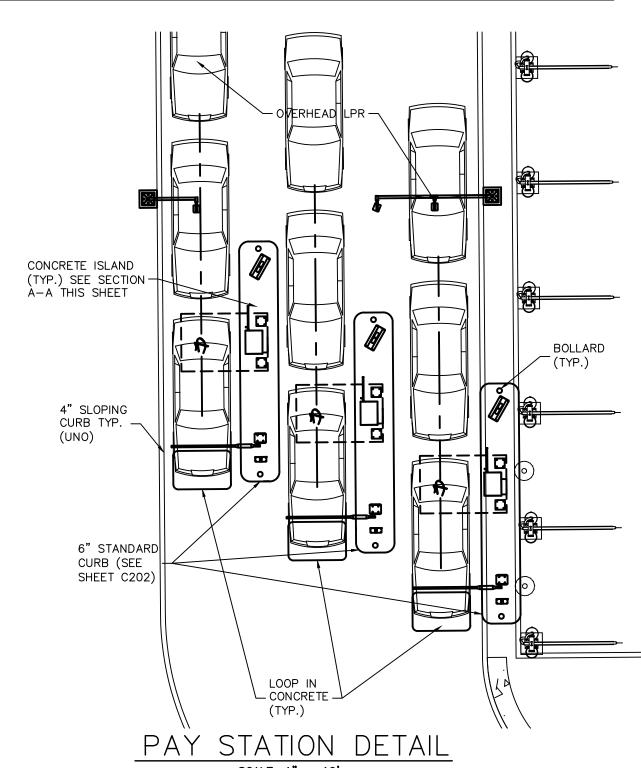



1. SEE ARCHITECTURAL PLANS FOR ELECTRICAL LAYOUT, EQUIPMENT, AND CANOPY DETAILS.

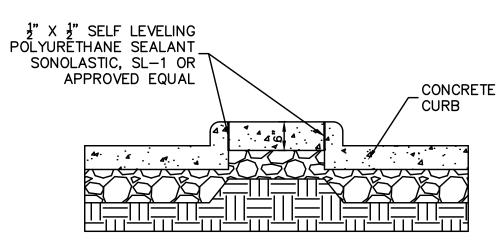

CALL BEFORE YOU DIG IN PENNSYLVANIA 1-800-242-1776 DESIGN SN: 20211762062 SECTION A-A
CONCRETE ISLAND DETAIL
N.T.S.



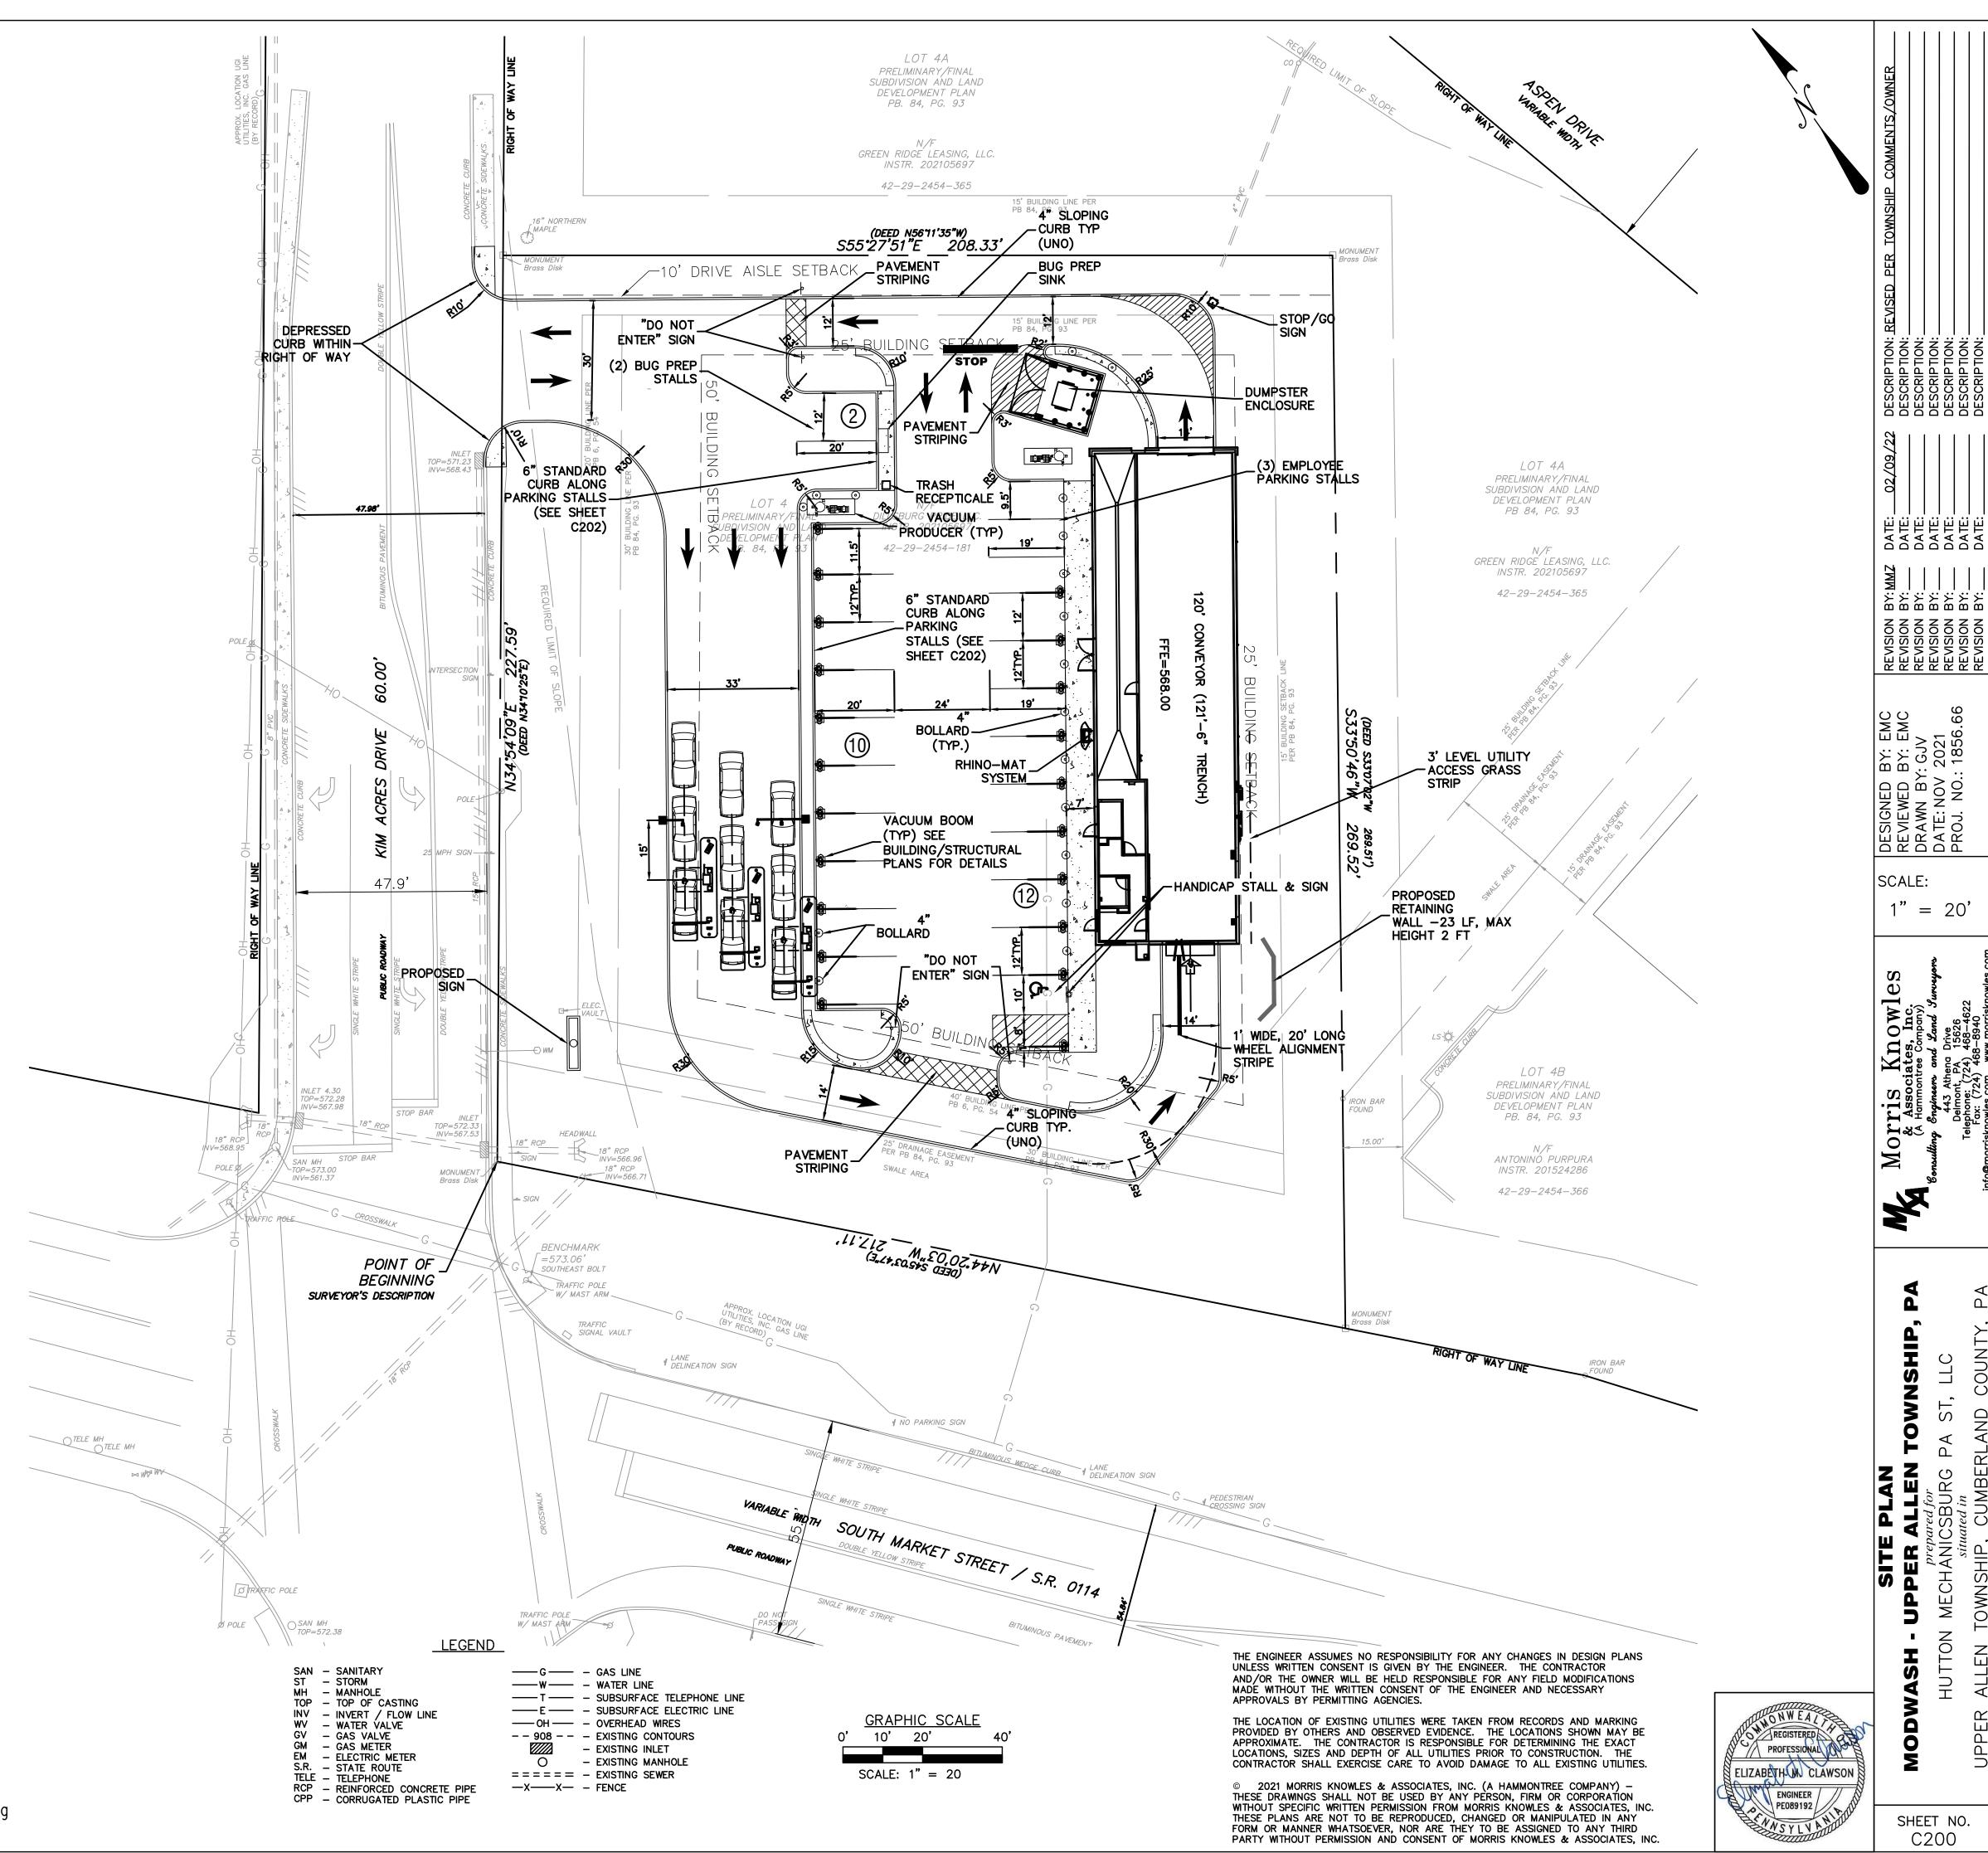

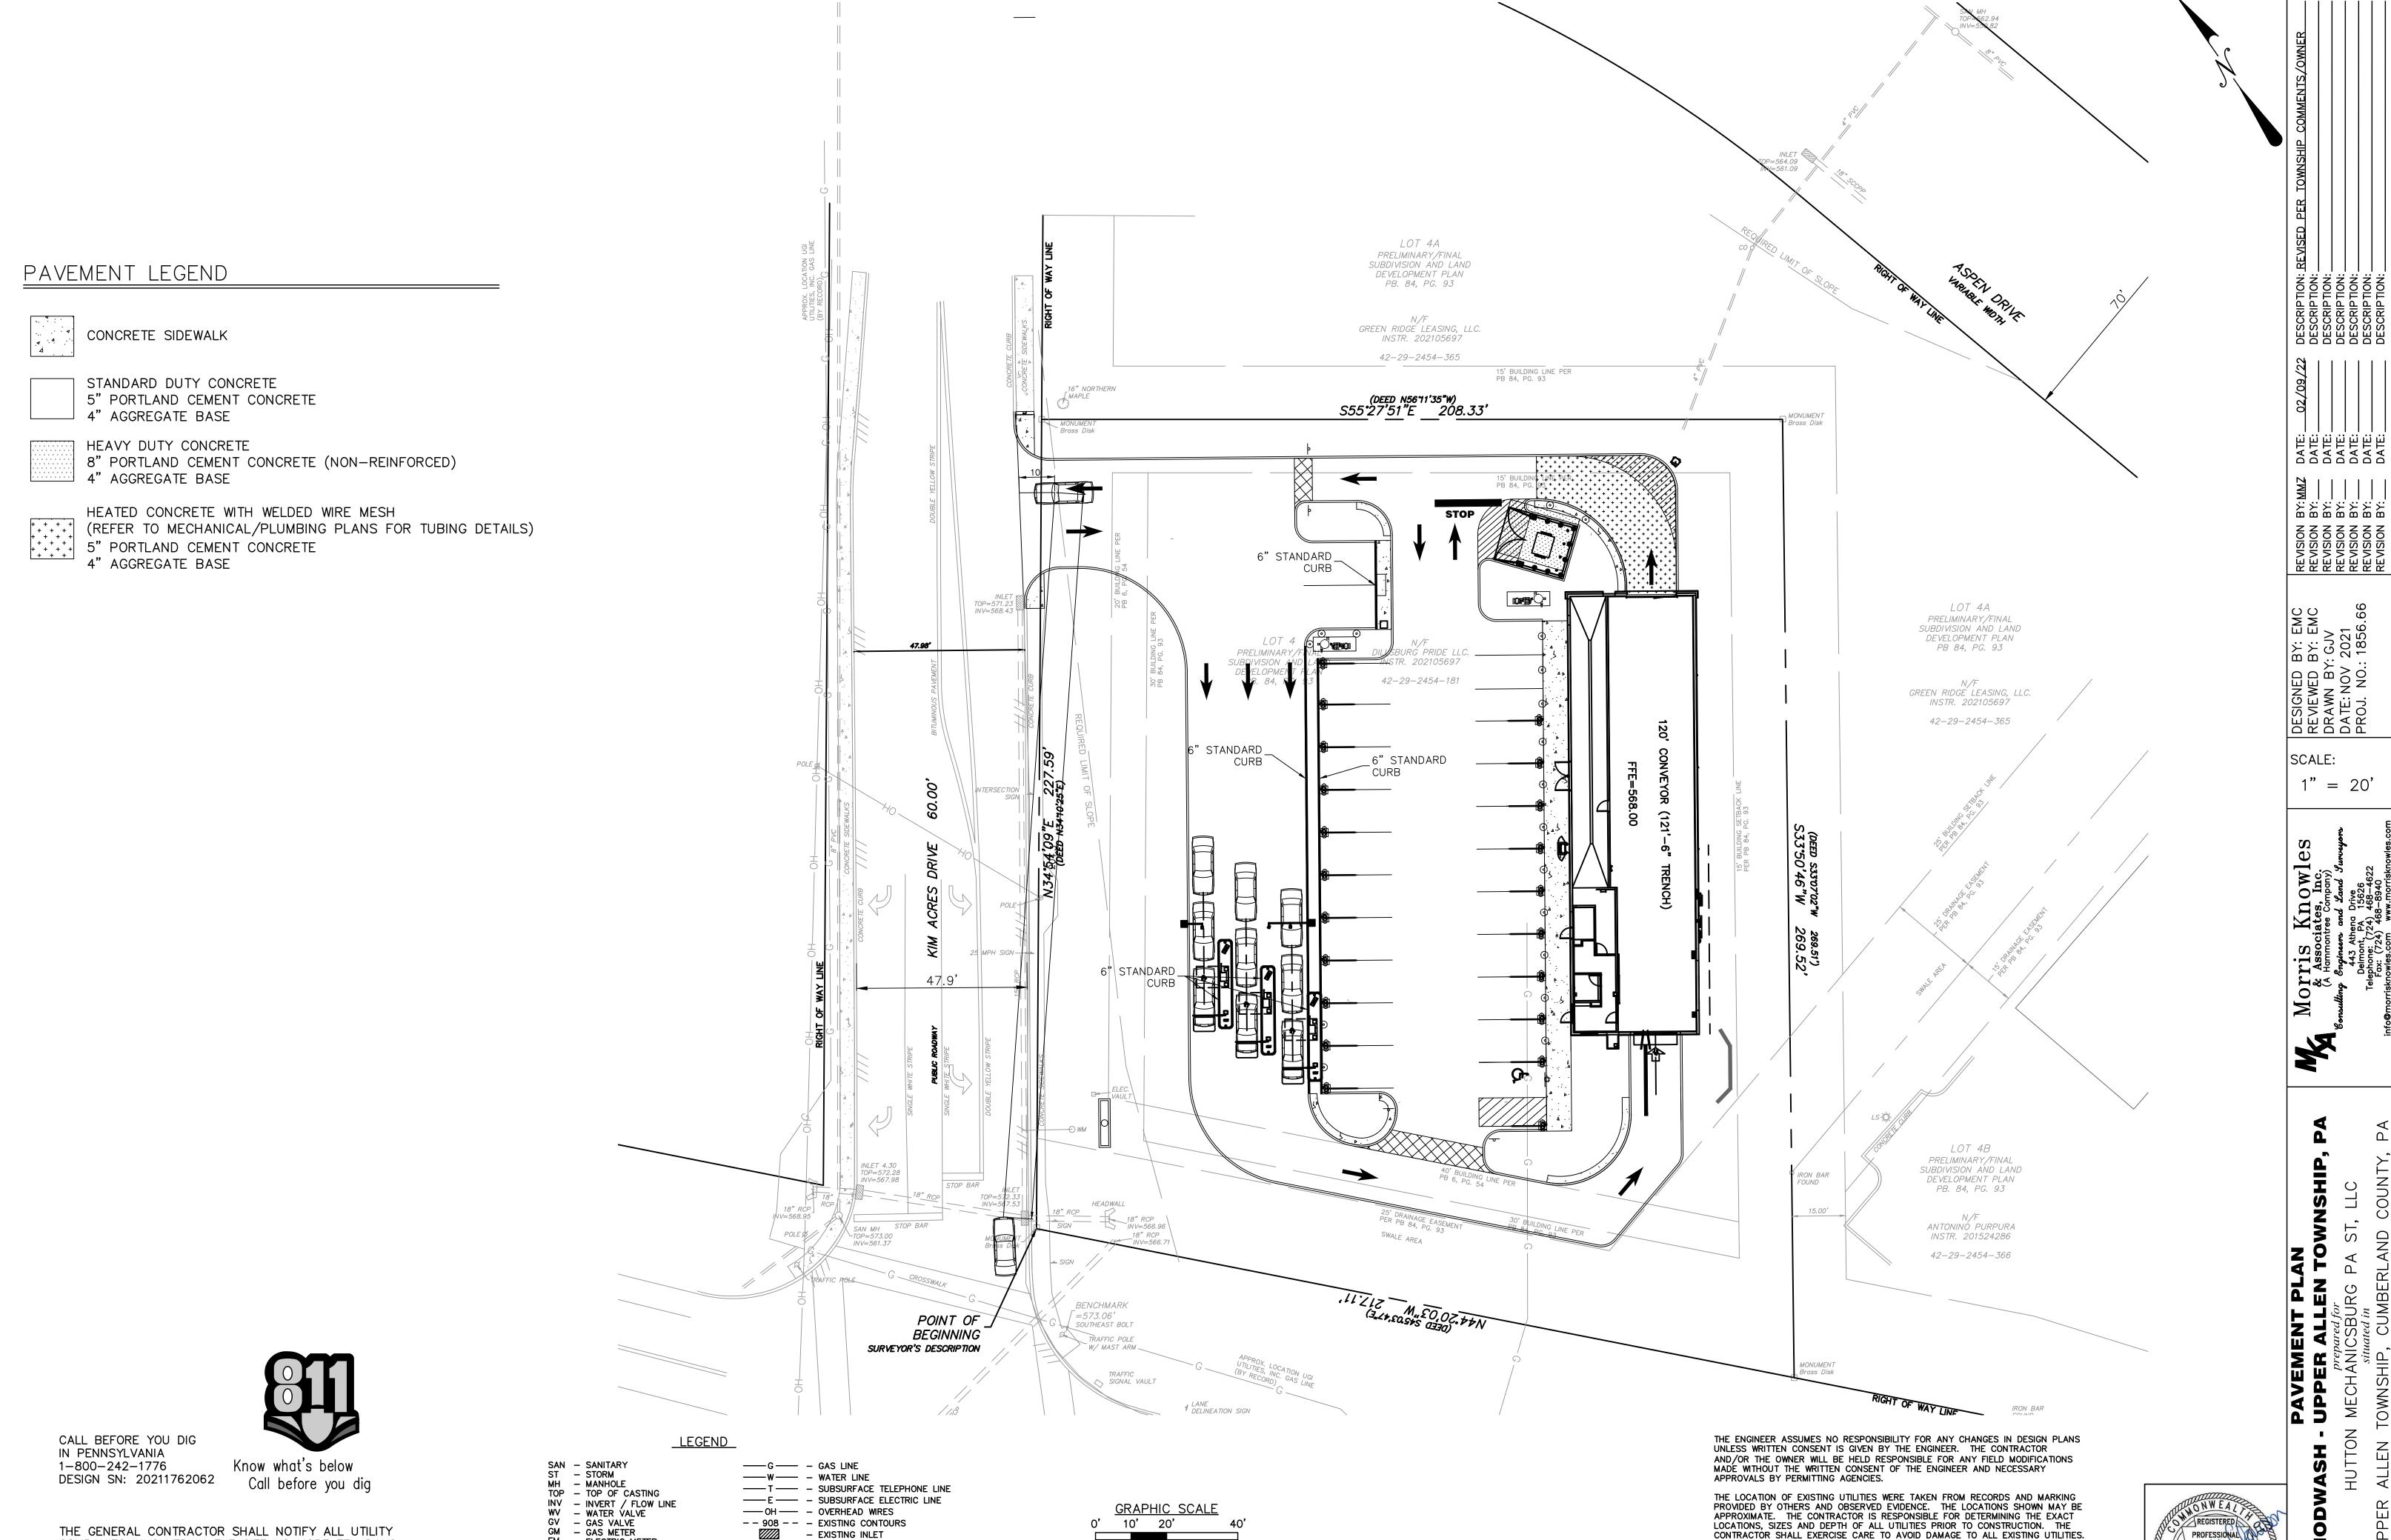

SCALE: 1" = 20

EM - ELECTRIC METER

RCP - REINFORCED CONCRETE PIPE

CPP - CORRUGATED PLASTIC PIPE

S.R. - STATE ROUTE

TELE - TELEPHONE

EXISTING MANHOLE

= = = = = EXISTING SEWER

—X——X— – FENCE

COMPANIES INVOLVED IN THE SITE NO MORE TEN DAYS

(PA ACT 287 OF 1974 AMENDED BY ACT 50 OF 2018).

PA STATE LAW REQUIRES 3 WORKING DAYS NOTICE

AND NO LESS THAN THREE DAYS IN ADVANCE OF EXCAVATION

ELIZABETH UN CLAWSON ENGINEER PE089192

© 2021 MORRIS KNOWLES & ASSOCIATES, INC. (A HAMMONTREE COMPANY) -


THESE DRAWINGS SHALL NOT BE USED BY ANY PERSON, FIRM OR CORPORATION

THESE PLANS ARE NOT TO BE REPRODUCED, CHANGED OR MANIPULATED IN ANY FORM OR MANNER WHATSOEVER, NOR ARE THEY TO BE ASSIGNED TO ANY THIRD

WITHOUT SPECIFIC WRITTEN PERMISSION FROM MORRIS KNOWLES & ASSOCIATES, INC.

PARTY WITHOUT PERMISSION AND CONSENT OF MORRIS KNOWLES & ASSOCIATES, INC.

SHEET NO. C201

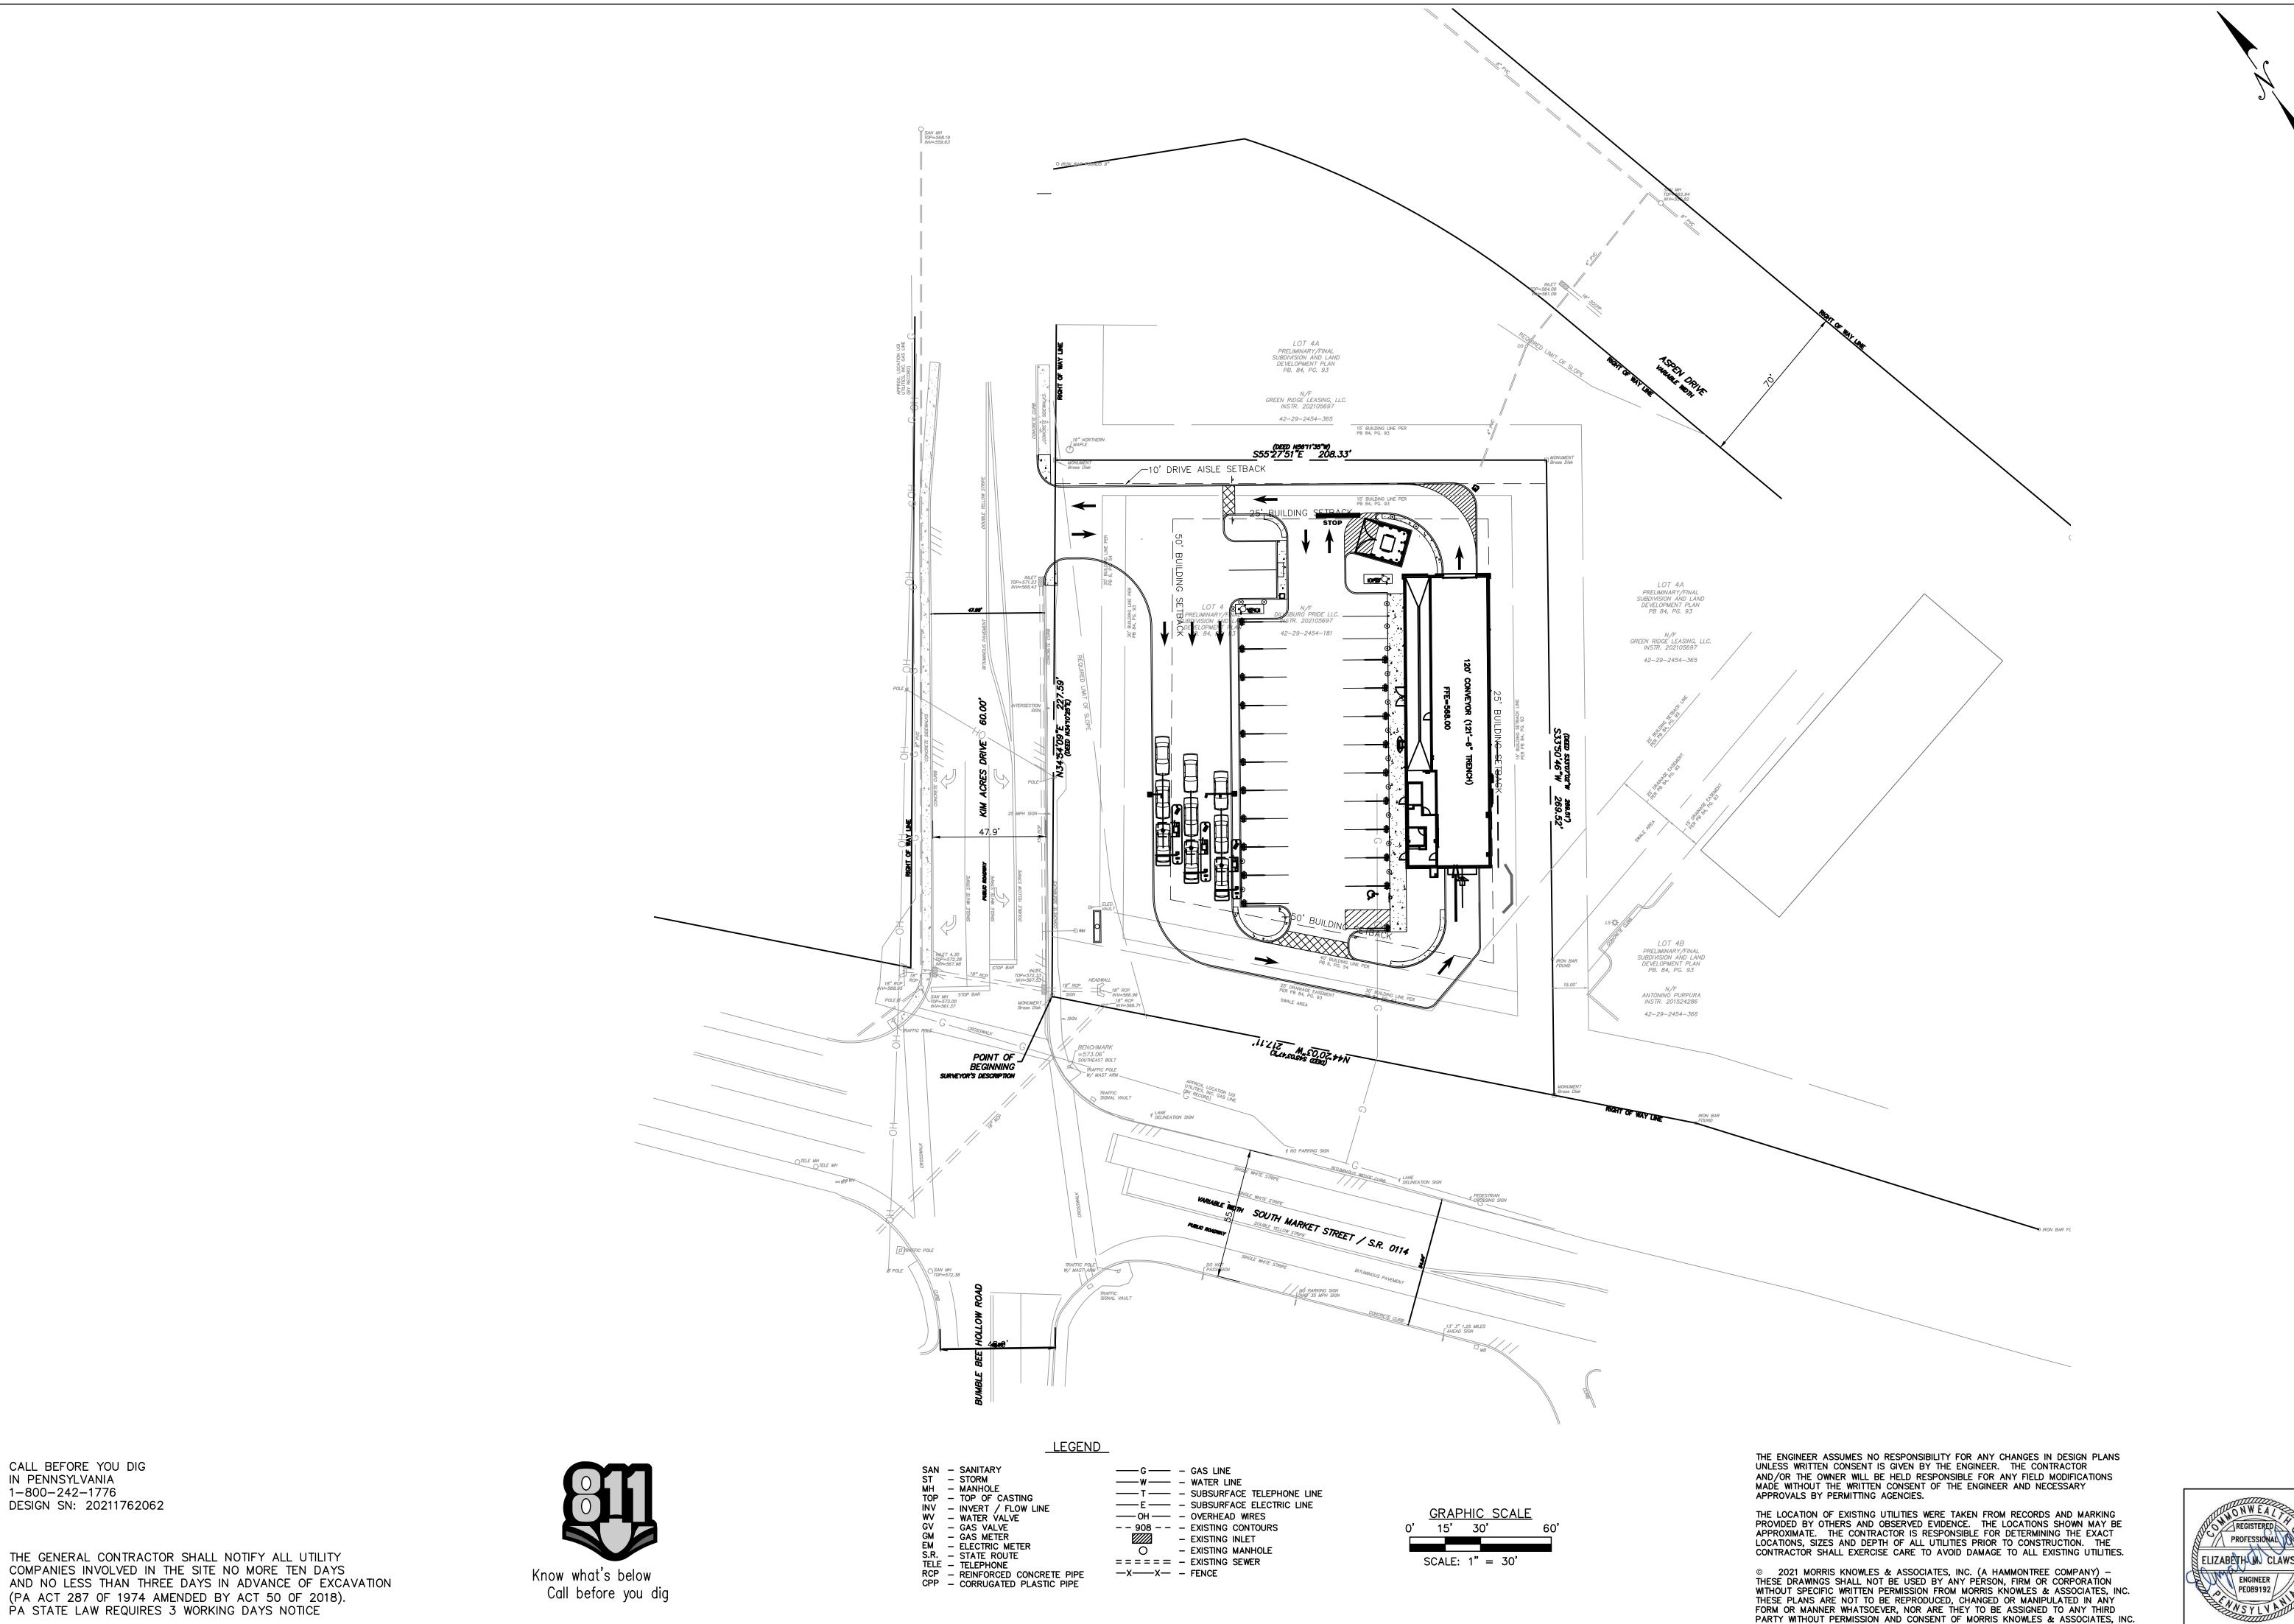

ELIZABETH UN CLAWSON ENGINEER PEO89192

SHEET NO. C202

DATE: DATE: DATE: DATE: DATE:

DESIGNED BY: E REVIEWED BY: E DRAWN BY: GJV DATE: NOV 2021 PROJ. NO.: 1856


1" = 30'

SCALE:

Morris & Assoc (A Hammo

GRADING NOTES:

- 1. THE CONTRACTOR SHALL COMPACT ALL FILL MATERIALS OUTSIDE OF PROPOSED BUILDING AREAS, PLACED IN LIFTS, AND COMPACTED TO 90% OF MAXIMUM DRY DENSITY, AS DETERMINED BY ASTM D-1557 (MODIFIED PROCTOR) OR 95% BY ASTM-D698 (STANDARD PROCTOR). PLACE FILL IN EIGHT-INCH LIFTS AND COMPACT WITH AN IMPACT-TYPE ROLLER (I.E. SHEEPSFOOT ROLLER). PROVIDE FOR INSPECTION OF ALL FILL AS IT IS PLACED FOR PROPER DENSITY BY A GEOTECHNICAL TESTING FIRM.
- 2. ALL CUT AND FILL OPERATIONS SHALL FOLLOW THE "PENNSYLVANIA HANDBOOK OF BEST MANAGEMENT PRACTICES" FOR DEVELOPING AREAS.
- 3. THE CONTRACTOR SHALL NOT EXCEED A MAXIMUM GRADE BREAK OF 8% IN THE PROPOSED DRIVEWAYS.
- 4. THE CONTRACTOR SHALL CONTROL DUST ON THE SITE IN ACCORDANCE WITH PA DEP REQUIREMENTS.
- 5. THE CONTRACTOR SHALL NOT REMOVE SOIL FROM THE SITE. IF THE CONTRACTOR DISCOVERS CONTAMINATED SOIL ON THE SITE DURING CONSTRUCTION ACTIVITIES, THEN THE SOILS SHALL BE CLEANED AND DISPOSED OF AT AN APPROVED LANDFILL IN ACCORDANCE WITH PADEP RULES, REGULATIONS AND REQUIREMENTS.
- 6. HANDICAPPED SPACES AND ACCESS ISLES MAXIMUM SLOPE IS 2% IN ALL DIRECTIONS.

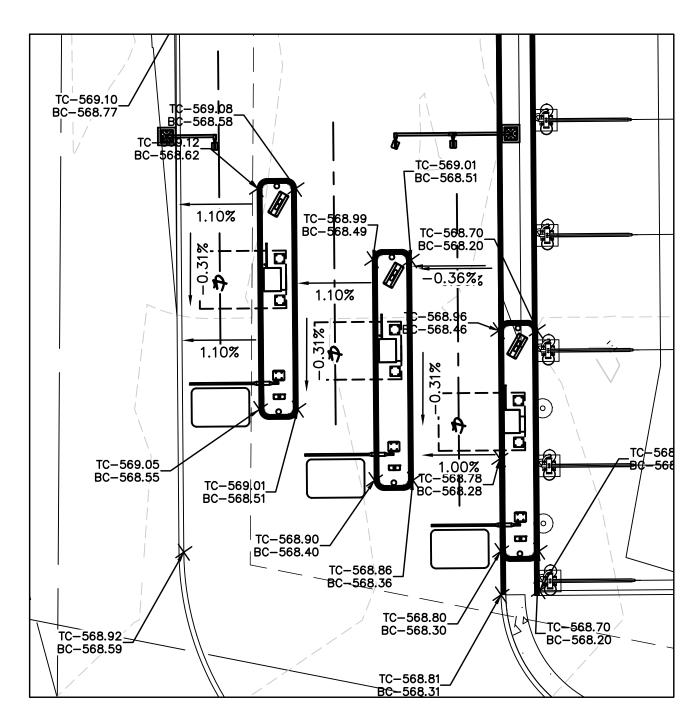


PAY STATION DETAIL


SCALE: 1" = 10'



CALL BEFORE YOU DIG IN PENNSYLVANIA 1-800-242-1776 DESIGN SN: 20211762062

Know what's below Call before you dig

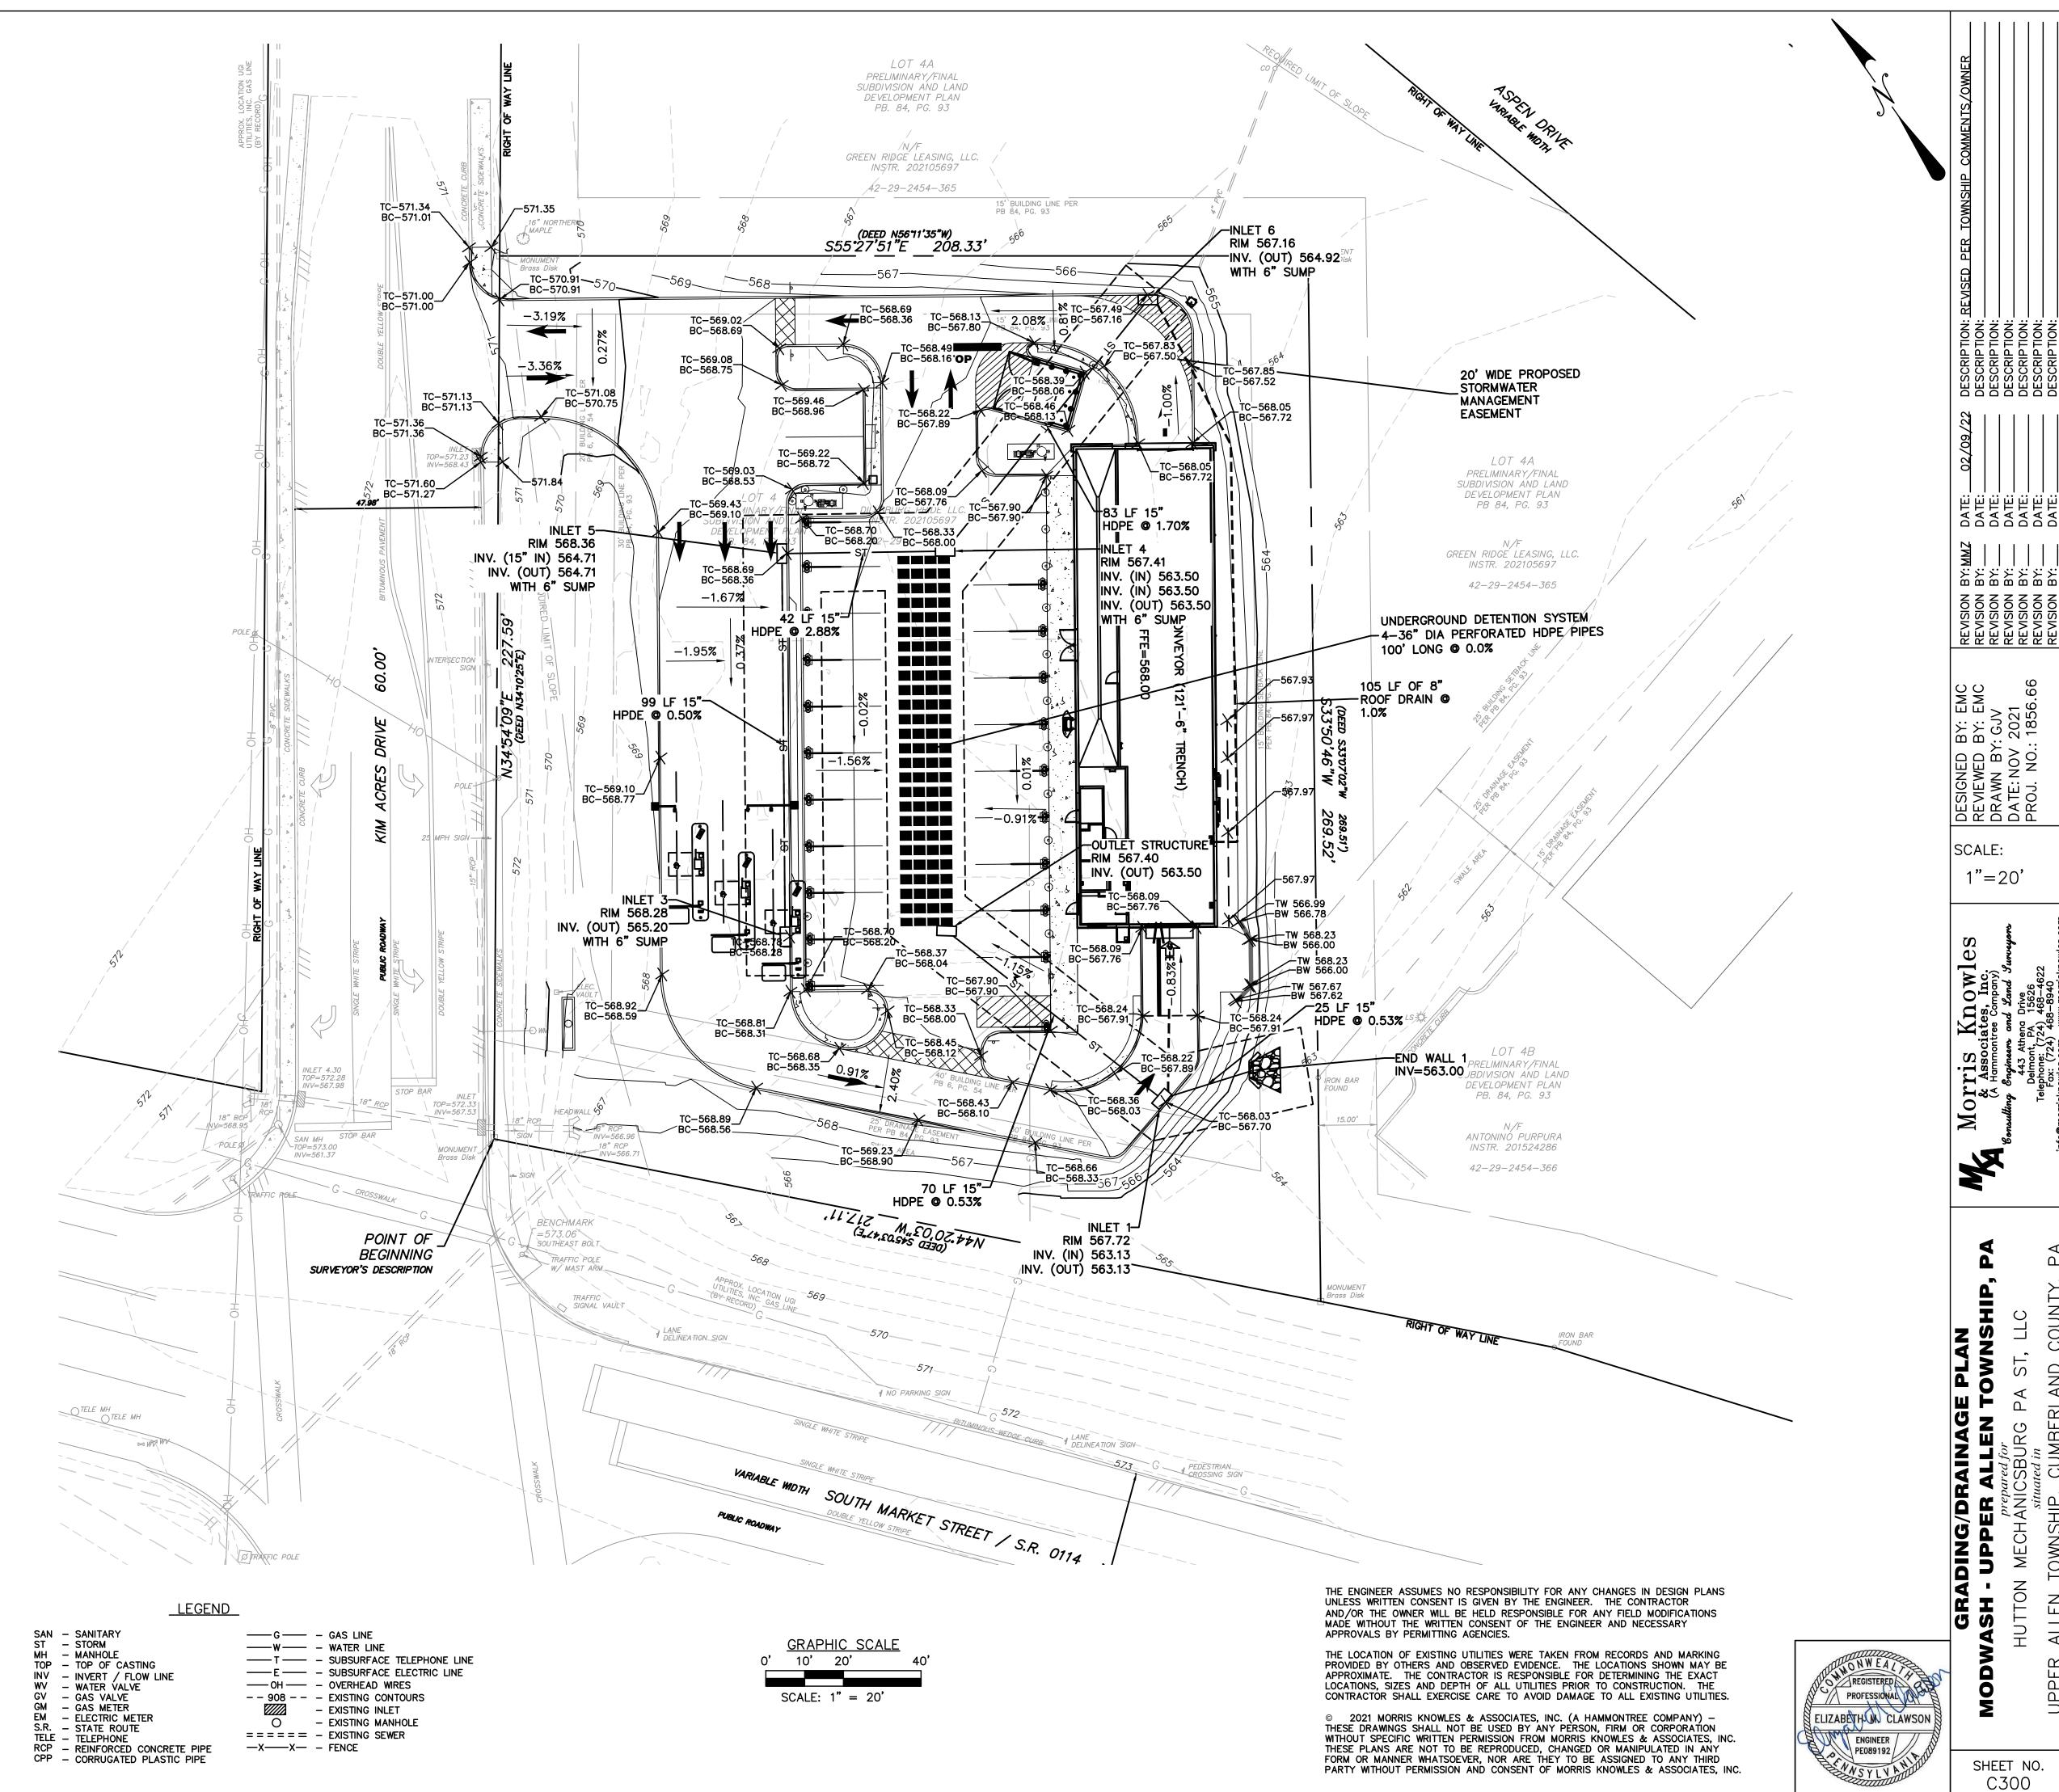

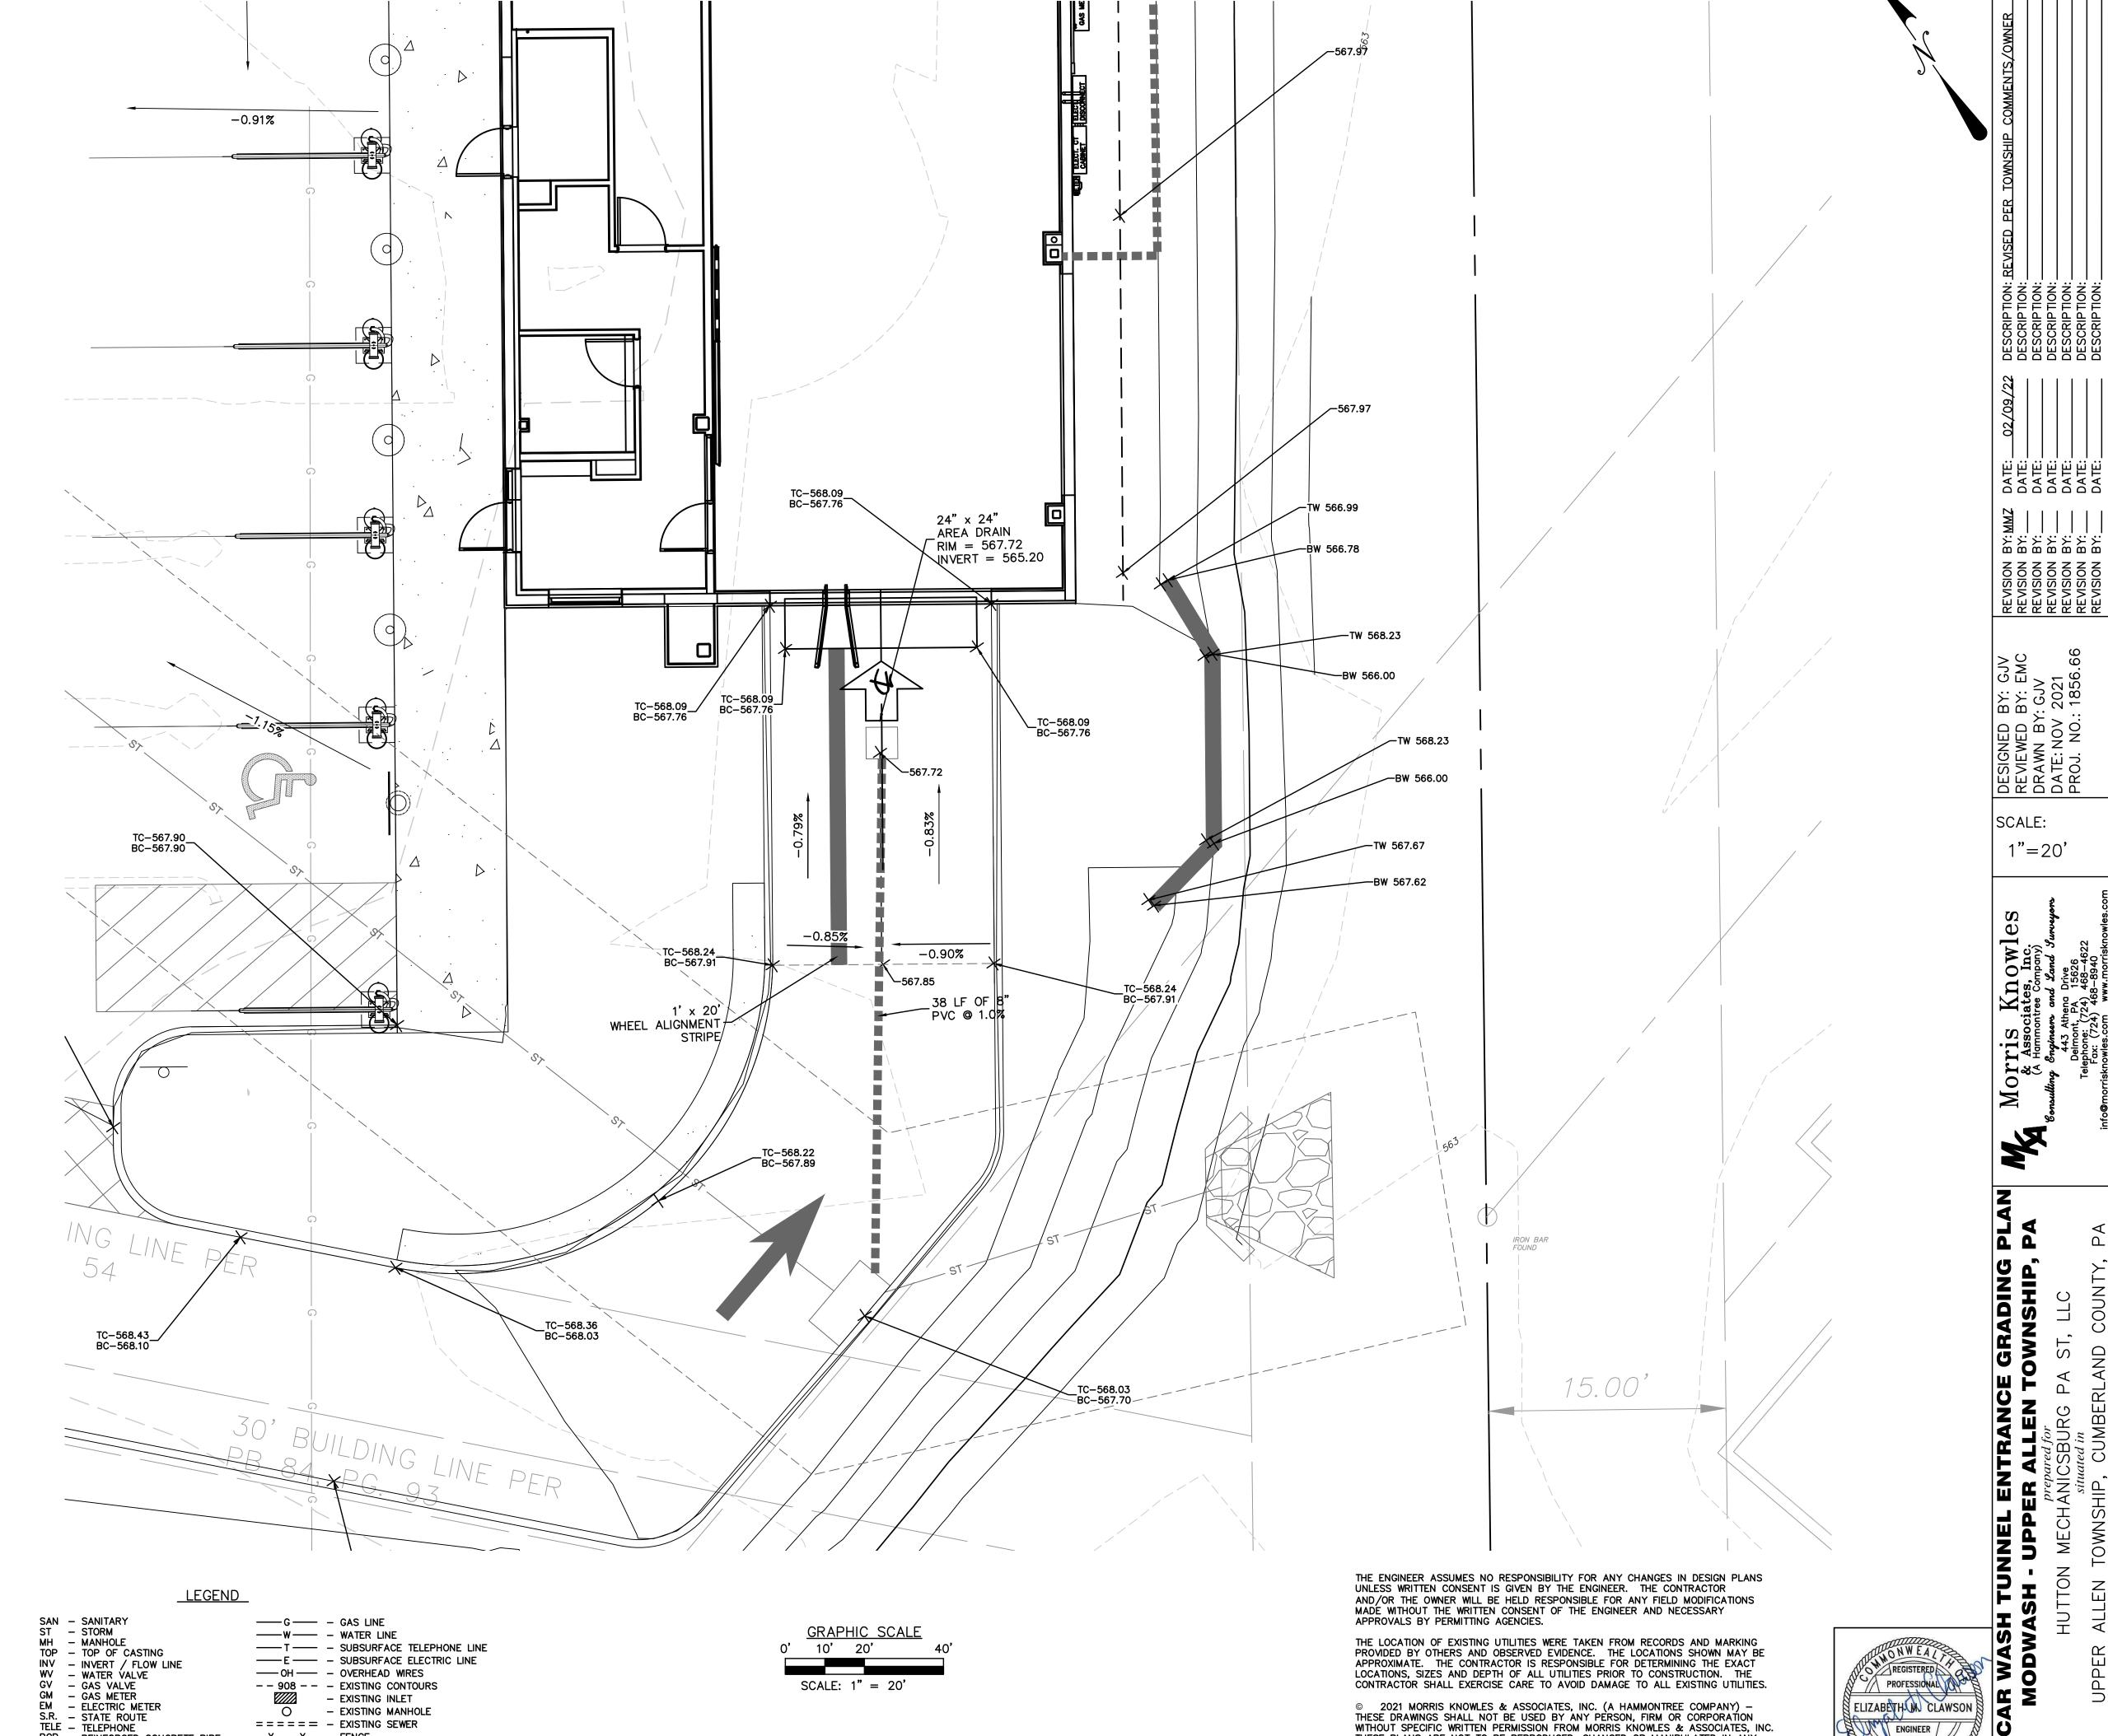

CALL BEFORE YOU DIG IN PENNSYLVANIA Know what's below 1-800-242-1776 DESIGN SN: 20211762062 Call before you dig

THE GENERAL CONTRACTOR SHALL NOTIFY ALL UTILITY COMPANIES INVOLVED IN THE SITE NO MORE TEN DAYS AND NO LESS THAN THREE DAYS IN ADVANCE OF EXCAVATION (PA ACT 287 OF 1974 AMENDED BY ACT 50 OF 2018). PA STATE LAW REQUIRES 3 WORKING DAYS NOTICE

EXISTING MANHOLE

= = = = = EXISTING SEWER

—X——X— – FENCE

RCP – REINFORCED CONCRETE PIPE CPP – CORRUGATED PLASTIC PIPE

ELIZABETH IN CLAWSON ENGINEER PE089192

© 2021 MORRIS KNOWLES & ASSOCIATES, INC. (A HAMMONTREE COMPANY) -


THESE DRAWINGS SHALL NOT BE USED BY ANY PERSON, FIRM OR CORPORATION

WITHOUT SPECIFIC WRITTEN PERMISSION FROM MORRIS KNOWLES & ASSOCIATES, INC.

THESE PLANS ARE NOT TO BE REPRODUCED, CHANGED OR MANIPULATED IN ANY FORM OR MANNER WHATSOEVER, NOR ARE THEY TO BE ASSIGNED TO ANY THIRD PARTY WITHOUT PERMISSION AND CONSENT OF MORRIS KNOWLES & ASSOCIATES, INC.

SHEET NO. C301

1"=20'

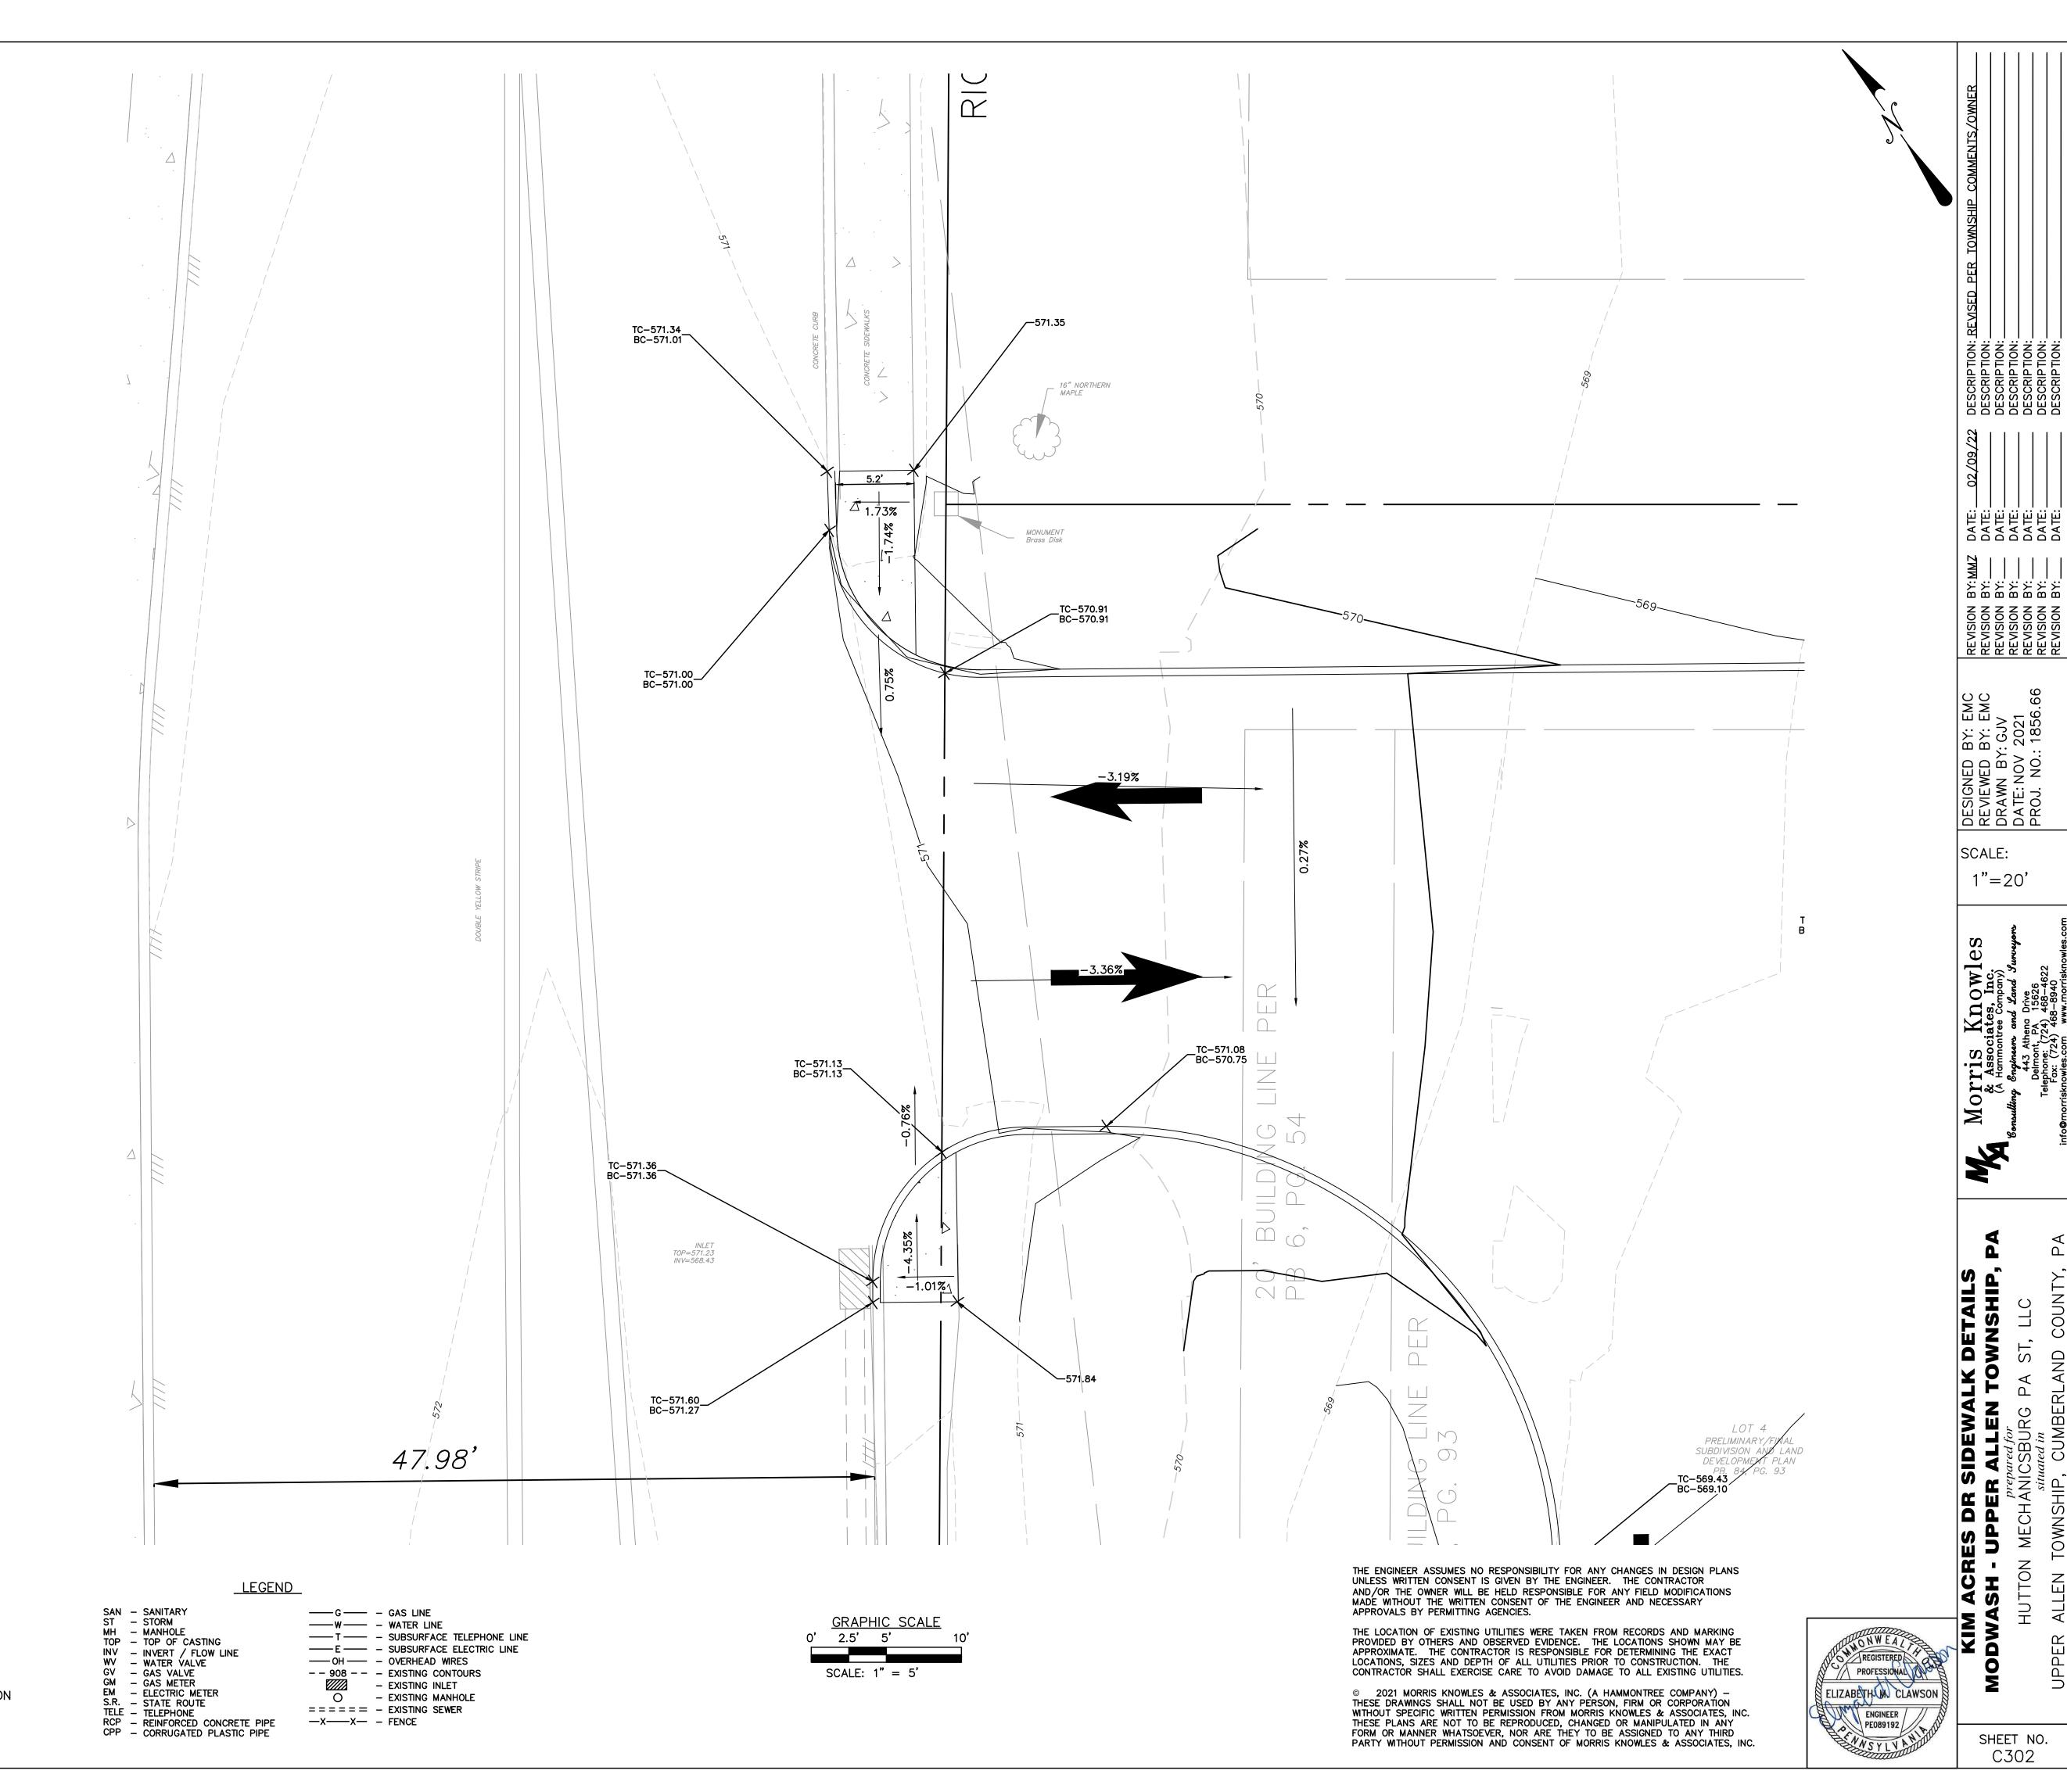

CALL BEFORE YOU DIG
IN PENNSYLVANIA
1-800-242-1776
DESIGN SN: 20211762062

Know what's below
Call before you dig

WATERLINE NOTES:

- 1. WATERLINE SHALL CONFORM TO AWWA C900 FOR PVC PLASTIC PIPE. PVC WATERLINE PIPE SHALL BE CLASS 200, DR-14 PVC PIPE. FITTINGS SHALL CONFORM TO AWWA C110.
- 2. WATERLINES CROSSING SEWERS SHALL BE LAID TO PROVIDE A MINIMUM VERTICAL DISTANCE OF 18 INCHES BETWEEN THE OUTSIDE OF THE WATERLINE AND THE OUTSIDE OF THE SEWER. THIS SHALL BE THE CASE WHERE THE WATERLINE IS EITHER ABOVE OR BELOW THE SEWER. AT CROSSINGS, ONE FULL LENGTH OF WATER PIPE SHALL BE LOCATED SO BOTH JOINTS WILL BE AS FAR FROM THE SEWER AS POSSIBLE. SPECIAL STRUCTURAL SUPPORT FOR THE WATER AND SEWER PIPES MAY BE REQUIRED.
- 3. ALL TYPES OF INSTALLED WATER PIPE SHALL BE PRESSURE TESTED AND LEAKAGE TESTED IN ACCORDANCE WITH THE LASTEST EDITION OF AWWA STANDARD C600.
- 4. ALL NEW, CLEANED OR REPAIRED WATERLINES SHALL BE DISINFECTED IN ACCORDANCE WITH AWWA STANDARD C651.
- 5. ALL WATERLINE PIPES, FITTINGS AND ACCESSORIES SHALL CONFORM TO THE REQUIREMENTS OF THE FOLLOWING STANDARD SPECIFICATIONS: A.21.10 ANSI, A.21.11 ANSI, A.21.50 ANSI, A.21.51 ANSI, AND A.21.4 ANSI.
- 6. SHOP DRAWINGS AND CATALOG CUTS FOR ALL MATERIALS USED IN CONSTRUCTION MUST BE APPROVED BY THE AUTHORITY PRIOR TO THE START OF WORK.
- 7. ALL MATERIALS FOR THE PROPOSED WATERLINE SHALL BE PURCHASED FROM THE MUNICIPAL AUTHORITY OF CUMBERLAND COUNTY.
- 8. THE PROPOSED WATERLINE SHALL BE IN ACCORDANCE WITH THE MUNICIPAL AUTHORITY OF CUMBERLAND COUNTY SPECIFICATIONS. THE AUTHORITY WILL INSPECT THE INSTALLATION OF WATERLINES AND CONNECTIONS.

UTILITY NOTES:

- 1. ALL EXISTING UTILITIES SERVING THIS PROPERTY SHALL BE PROPERLY TERMINATED AT THE RIGHT-OF-WAY LINE IN COMPLIANCE WITH TOWNSHIP AND COUNTY REGULATIONS. CONTRACTOR SHALL PROVIDE EVIDENCE OF COMPLIANCE WITH ALL STATE AND FEDERAL LAWS REGARDING THE DEMOLITION OF STRUCTURES AND ABANDONMENT OF UTILITIES.
- 2. ANY UTILITIES FOUND DURING EXCAVATION, NOT SHOWN ON PLAN, SHALL BE BROUGHT TO THE IMMEDIATE ATTENTION OF THE ENGINEER.
- 3. EACH SUBCONTRACTOR SHALL OBTAIN HIS OR HER OWN PERMITS AND CONTACT THE UTILITY COMPANY FOR VERIFICATION AND LOCATION OF HOOK-UP PRIOR TO ANY WORK BEING DONE.
- 4. UTILITIES SHOWN WERE TAKEN IN PART FROM RECORDS OF RESPECTIVE UTILITY COMPANIES AND PART FROM A SURVEY AND DO NOT NECESSARILY REPRESENT ALL UNDERGROUND OR OVERHEAD UTILITIES ADJACENT TO OR UPON THE PREMISES SHOWN ON THE PLAN.
- 5. THE CONTRACTOR SHALL COORDINATE UTILITY CONNECTIONS AND SIZE AT THE BUILDING WITH THE MECHANICAL DRAWINGS AND PROVIDE CONNECTIONS WITH EXISTING UTILITIES IN ACCORDANCE WITH THE UTILITY PROVIDER'S REQUIREMENTS.
- 6. ALL UTILITIES SHALL BE UNDERGROUND.
- 7. ALL UTILITIES SHALL BE CONSTRUCTED, INSPECTED AND TESTED IN ACCORDANCE WITH THE BOROUGH, CITY, AUTHORITY, OR COUNTY STANDARDS AND REGULATIONS. THE ENGINEERING DEPARTMENT SHALL BE NOTIFIED A MINIMUM OF 24 HOURS IN ADVANCE FOR SCHEDULING OF AN INSPECTOR IF REQUIRED.
- 8. ROOF DRAINS, FOUNDATION DRAINS AND OTHER CLEAN WATER CONNECTIONS TO THE SANITARY SEWER ARE PROHIBITED.
- 9. CONTRACTOR SHALL VERIFY THE LOCATION AND INVERTS OF ALL EXISTING UTILITIES PRIOR TO CONSTRUCTION.
- 10. THE CONTRACTOR SHALL COORDINATE ALL UTILITY CONNECTIONS AND SHUT-OFFS WITH UTILITY
- 11. THE CONTRACTOR SHALL COORDINATE THE ARCHITECTURAL ROOF DRAIN LOCATIONS WITH THE SITE PLAN AND OUTLET THEM INTO THE NEAREST INLET BOX.

SANITARY SEWER NOTES:

- 1. SANITARY SEWER LATERAL SHALL BE 6" DIAMETER OF PVC ASTM D-3034, SDR-35 WITH RUBBER GASKET JOINTS OR APPROVED EQUAL. LATERALS SHALL BE CONSTRUCTED WITH MINIMUM 1.0% SLOPE AND HAVE A MINIMUM OF 4'-0" COVER.
- 2. SANITARY SEWER MAINS SHALL BE 8" DIAMETER OF PVC ASTM D-3034, SDR-35 WITH RUBBER GASKET JOINTS OR APPROVED EQUAL. LATERALS SHALL BE CONSTRUCTED WITH MINIMUM 1.0% SLOPE AND HAVE A MINIMUM OF 4'-0" COVER.
- 3. ROOF DRAINS, FOUNDATION DRAINS AND OTHER CLEAN WATER CONNECTIONS TO THE SANITARY SEWER ARE PROHIBITED.
- 4. SANITARY SEWERS SHALL BE TESTED BY LOW PRESSURE AIR TESTS AND/OR OTHER TESTS AS REQUIRED BY THE AUTHORITY.
- 5. MANHOLE LIDS SHALL BE EQUIPPED WITH SELF-SEALING GASKETS.
- 6. SANITARY SEWER MANHOLES SHALL BE VACUUM TESTED.
- 7. THE MUNICIPAL AUTHORITY WILL INSPECT ALL SANITARY SEWER LINES AND LATERALS.
- 8. THE CONTRACTOR SHALL INSTALL NEW SANITARY SEWER LATERALS FROM THE BUILDING TO THE SANITARY SEWER MAIN LINE. EXISTING LATERALS UNDER EXISTING ROADS MAY BE USED, BUT THEY MUST BE VIDEOED AND LINED IN ACCORDANCE WITH THE AUTHORITY'S REQUIREMENTS.

THE ENGINEER ASSUMES NO RESPONSIBILITY FOR ANY CHANGES IN DESIGN PLANS UNLESS WRITTEN CONSENT IS GIVEN BY THE ENGINEER. THE CONTRACTOR AND/OR THE OWNER WILL BE HELD RESPONSIBLE FOR ANY FIELD MODIFICATIONS MADE WITHOUT THE WRITTEN CONSENT OF THE ENGINEER AND NECESSARY APPROVALS BY PERMITTING AGENCIES.

THE LOCATION OF EXISTING UTILITIES WERE TAKEN FROM RECORDS AND MARKING PROVIDED BY OTHERS AND OBSERVED EVIDENCE. THE LOCATIONS SHOWN MAY BE APPROXIMATE. THE CONTRACTOR IS RESPONSIBLE FOR DETERMINING THE EXACT LOCATIONS, SIZES AND DEPTH OF ALL UTILITIES PRIOR TO CONSTRUCTION. THE CONTRACTOR SHALL EXERCISE CARE TO AVOID DAMAGE TO ALL EXISTING UTILITIES.


© 2021 MORRIS KNOWLES & ASSOCIATES, INC. (A HAMMONTREE COMPANY) — THESE DRAWINGS SHALL NOT BE USED BY ANY PERSON, FIRM OR CORPORATION WITHOUT SPECIFIC WRITTEN PERMISSION FROM MORRIS KNOWLES & ASSOCIATES, INC. THESE PLANS ARE NOT TO BE REPRODUCED, CHANGED OR MANIPULATED IN ANY FORM OR MANNER WHATSOEVER, NOR ARE THEY TO BE ASSIGNED TO ANY THIRD PARTY WITHOUT PERMISSION AND CONSENT OF MORRIS KNOWLES & ASSOCIATES, INC.



CALL BEFORE YOU DIG IN PENNSYLVANIA 1–800–242–1776 DESIGN SN: 20211762062

Know what's below Call before you dig

THE GENERAL CONTRACTOR SHALL NOTIFY ALL UTILITY COMPANIES INVOLVED IN THE SITE NO MORE TEN DAYS AND NO LESS THAN THREE DAYS IN ADVANCE OF EXCAVATION (PA ACT 287 OF 1974 AMENDED BY ACT 50 OF 2018). PA STATE LAW REQUIRES 3 WORKING DAYS NOTICE

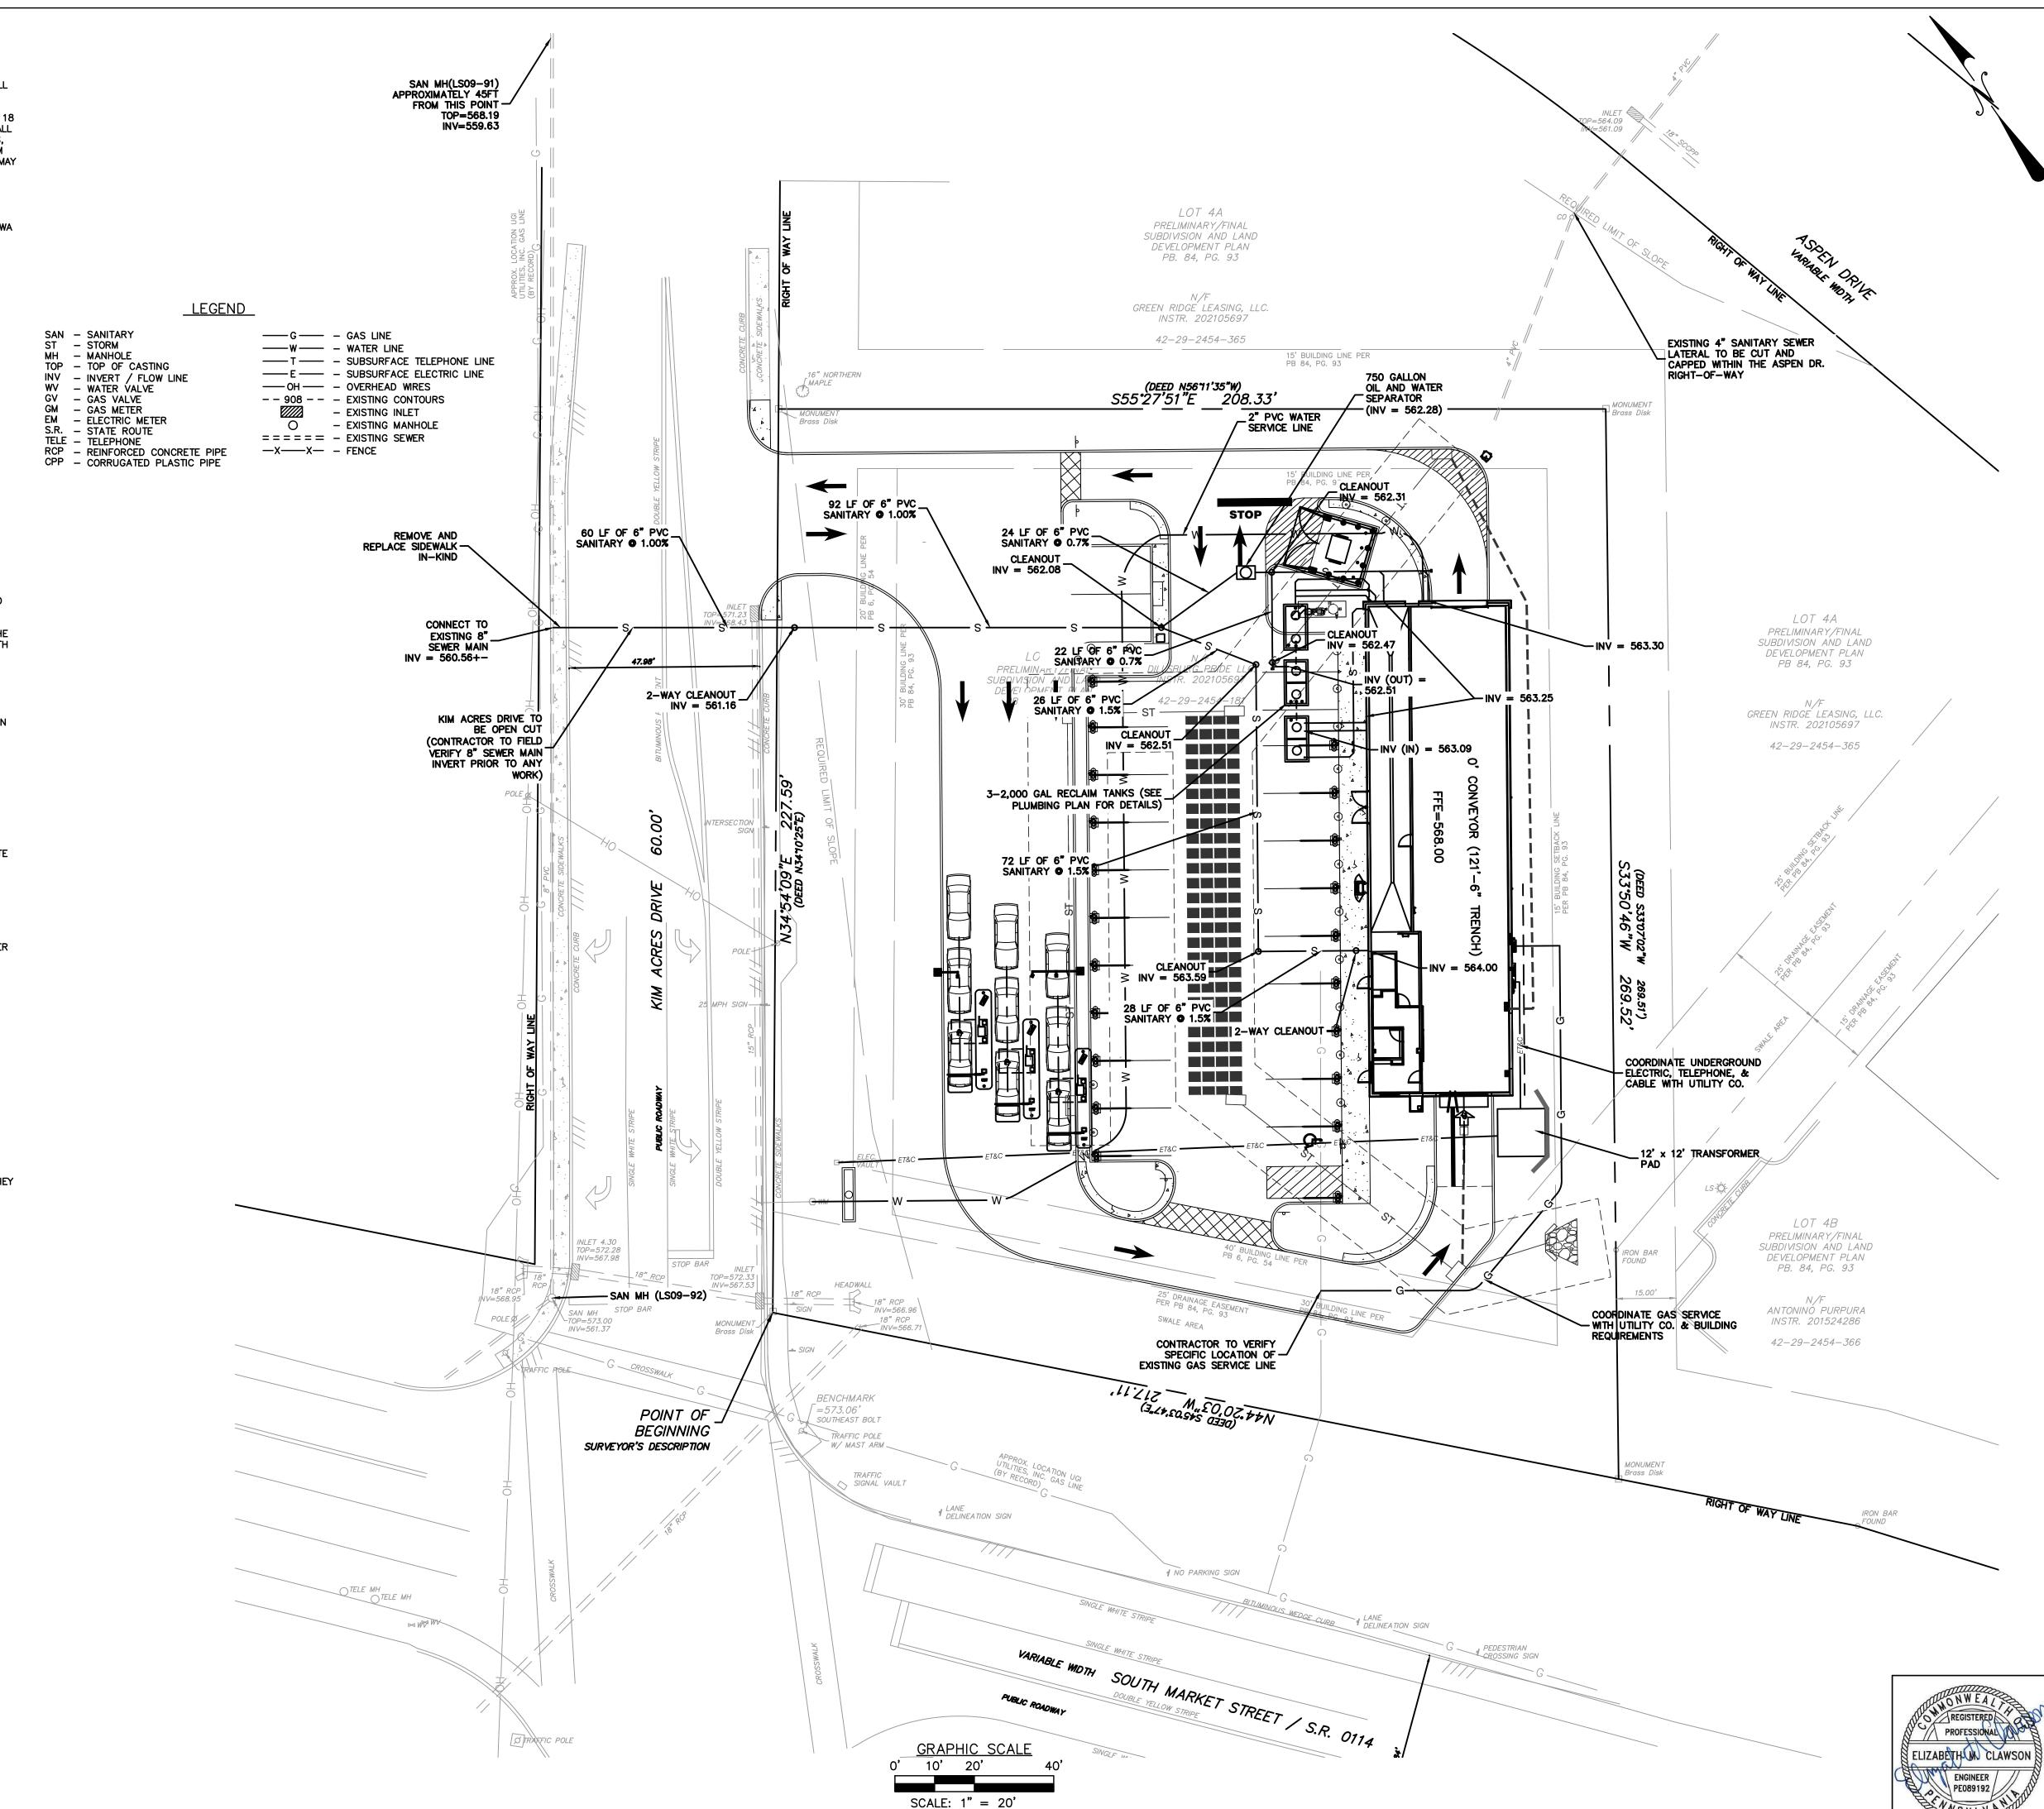

R R R R R R R

NED N BY NOV: NOV

SIGN VIEN VIEN OU.

1"=20'

SCALE:

es


7.%<

SHEET NO. C400

LANDSCAPING NOTES:

- 1. ALL PLANTING BEDS SHALL RECEIVE 3" DOUBLE SHREDDED BARK MULCH. 2. ALL PLANTING BEDS SHALL BE BACKFILLED WITH 6" DEPTH CLEAN TOPSOIL FREE OF BUILDING
- DEBRIS, CRUSHED ROCK, MORTAR MIX, ETC. 3. REPAIR/RESEED ALL DISTURBED AREAS WITH SPECIFIED SEED MIXTURES.
- 4. SEED ALL 2:1 OR STEEPER SLOPES WITH BIRDSFOOT TREFOIL AND TALL FESCUE MIX. 5. ALL DISTURBED AREAS LESS 2:1 SLOPE SHALL BE SEEDED WITH LAWN SEEDING MIXTURE. 6. ALL LAWN AREAS SHALL BE BACKFILLED WITH 6" DEPTH CLEAN TOPSOIL FREE OF BUILDING
- DEBRIS, CRUSHED ROCK, MORTAR MIX, ETC. 7. ALONG SIDEWALKS, FOUNDATIONS AND CURBINGS, UNDER-RUN FROM CONCRETE FORMS SHALL
- BE BROKEN AWAY AND REMOVED. 8. PRIOR TO CONSTRUCTION, IT SHALL BE THE RESPONSIBILITY OF THE CONTRACTOR TO DETERMINE IN THE FIELD THE LOCATIONS OF ALL EXISTING UTILITIES.
- 9. ALL PLANT MATERIALS SHALL BE OF SPECIMEN QUALITY AND COMPLY WITH THE AMERICAN STANDARD FOR NURSERY STOCK (MOST CURRENT EDITION),
- 10. ALL PLANT MATERIAL TO BE RE-USED SHALL BE TAGGED BY OWNER. ALL EXISTING PLANT MATERIAL TO BE RE-USED SHALL BE STORED AS SHOWN ON PLAN PRIOR TO PLANTING DURING CONSTRUCTION. 11. TREE TRUNKS AND EXPOSED ROOTS DAMAGED DURING EQUIPMENT OPERATIONS SHALL BE TREATED
- IN ACCORDANCE WITH ARBORICULTURAL STANDARDS. DAMAGED TREE LIMBS SHALL BE CUT BACK TO THE NEXT LATERAL BRANCH OR PARENT STEM AT THE BRANCH COLLAR. 12. ALL PLANTS SHALL BE BALLED AND WRAPPED OR CONTAINER GROWN AS
- CONTAINER GROWN STOCK WILL BE ACCEPTED IF IT IS ROOT BOUND. ALL ROOT WRAPPING MATERIAL MADE OF SYNTHETICS OR PLASTICS SHALL BE REMOVED AT TIME OF PLANTING.

 13. THE OWNER RESERVES THE RIGHT TO REJECT ANY AND ALL PLANT MATERIAL DEEMED NOT
- 14. ALL PLANTS AND STAKES SHALL BE SET PLUMB UNLESS OTHERWISE SPECIFIED. 15. REMOVE BURLAP, ROPES, WIRE, AND OTHER NON-BIODEGRADABLE MATERIALS
- BALLS AFTER FINAL POSITIONING. 16. SPADE CUT ALL BED EDGES AND MULCHED RINGS ARE TO BE SPADE CUT TO A DEPTH OF 6", CUT AT 90° TO THE FINISHED GRADE AND THEN BACK TOWARD THE PLANT BED AT 45°. 17. TOPSOIL SHALL BE FROM A NATURALLY WELL DRAINED SITE WHERE SOIL OCCURS AT A DEPTH OF AT LEAST 4". TOPSOIL SHOULD HAVE A pH OF 5.5 TO 7 WITH 4 PERCENT ORGANIC
- MATERIAL MINIMUM AND BE FREE OF STONES 1" DIAMETER OR LARGER, ROOTS, PLANTS, CLAY LUMPS AND OTHER MATERIALS HARMFUL TO PLANT GROWTH. 18. ALL PLANTS SHALL BE WATERED THOROUGHLY TWICE DURING THE FIRST 24-HOUR PERIOD AFTER PLANTING. ALL PLANTS SHALL THEN BE WATERED WEEKLY, IF NECESSARY, DURING THE FIRST GROWING SEASON.
- 19. THE CONTRACTOR SHALL BE RESPONSIBLE FOR REPLACING ALL DEAD PLANT MATERIAL FROM NATURAL CAUSES INSTALLED PURSUANT TO THESE REQUIREMENTS FOR A PERIOD OF ONE (1) YEAR AFTER THE INSTALLATION DATE. IT SHALL BE THE RESPONSIBILITY OF THE OWNER/APPLICANT TO ASSURE THE CONTINUED GROWTH OF ALL REQUIRED LANDSCAPING AND/OR TO REPLACE THE SAME IN THE EVENT OF FROST, VANDALISM, DISEASE, OR OTHER REASONS FOR DISCONTINUED GROWTH OF THE REQUIRED TREES, SHRUBS, AND BRUSHES. IT IS THE OWNER'S RESPONSIBILITY FOR ALL FUTURE MAINTENANCE. NO PERSON SHALL REMOVE ANY LANDSCAPING (i.e. TREES, SHRUBS, OR BRUSHES) AFTER THE SAME HAS BEEN PLANTED UNLESS THE SAME ARE REPLACED WITH AN EQUIVALENT TREE, SHRUB, OR BUSH.
- 20. PERMANENT SEEDING SHALL BE REQUIRED FOR ALL DISTURBED SLOPE AREAS WITHIN FOURTEEN
- (14) DAYS OF COMPLETION OF GRADING OPERATIONS, WEATHER PERMITTING. 21. THE CONTRACTOR SHALL NOT PLANT SHRUBS IN AREAS UNDERLAIN BY SHALLOW DEPTH TO ROCK. 22. AFTER PLANTS ARE ESTABLISHED, ALL PLANT STAKING SHALL BE REMOVED.

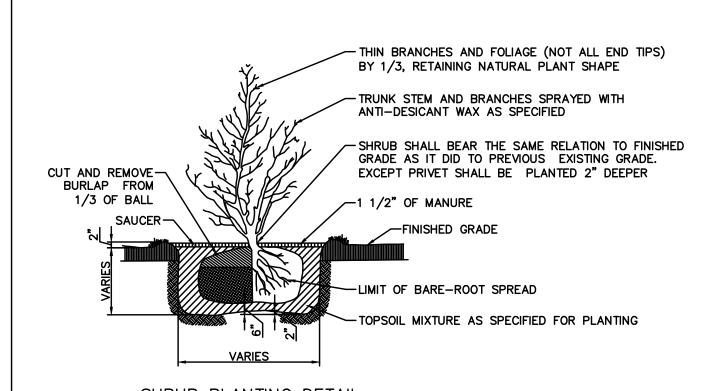

PLANT MUST BE SET AT -NURSERY DEPTH - STAKING OF TREES IS CONTRACTORS OPTION, REMOVE BURLAP FROM -HOWEVER TREES MUST BE PLUMB AT TIME OF FINAL TOP 1/3 OF BALL ACCEPTANCE EVERGREEN TREES
TOPSOIL MIXTURE*

• 4 PARTS TOPSOIL • 1 PART HUMUS

• WHERE DRAINAGE IS POOR, PROVIDE 8" DIAMETER HOLE 12" DEEP AND FILL WITH 2B GRAVEL.

PLANT CALCULATIONS: TABLE

NOT REQUIRED - ALL ADJACENT PROPERTIES ARE ZONED C-2

STREET TREES: TREES SHALL BE PLANTED
BETWEEN STREET RIGHT-OF-WAY LINE AND
BUILDING SETBACK LINE AT LEAST 5 FEET
FROM THE SIDEWALK.
A MINIMUM OF 2 CANOPY TREES PER 100
FEET OF PUBLIC RIGHT-OF-WAY.
TREES SHALL BE PLACED A MINIMUM OF 40
FEET APART ALONG RIGHT-OF-WAY

DUMPSTER SCREENING: 1 SHADE TREE PER 40 LINEAR FEET AND 1 EVERGREEN TREE PER FIVE LINEAR FEET OF VISIBILITY PLUS A

6' SOLID FENCE.

REQUIRED

LANDSCAPING ISLANDS 220-5.13 (2)

PROVIDED

DEVELOPED AREA TOTAL = 0.98 AC

PROPOSED LANDSCAPED AREA = 0.11 AC

TOTAL FRONTAGE: 445 FEET TOTAL TREES PROVIDED: 9 LARGE TREES

A 6' TALL SOLID ENCLOSURE HAS BEEN PROVIDED.

REQUIREMENTS (10%) = 0.10 AC

TREE PER ISLAND

SHADE TREES REQUIRED: 1 SHADE TREES PROVIDED: 1

PERMANENT STABILIZATION

- POA PRATENSIS (KENTUCKY BLUEGRASS) 90% PURE LIVE SEED, APPLICATION RATE 50LBS/AC
- FESTUCA RUBRA VAR. 'PENNLAWN" (PENNLAWN RED FESCUE)
- 98% PURE LIVE SEED, APPLICATION RATE 30LBS/AC • LOLIUM PERENNE (PERENNIAL RYEGRASS) 98% PURE LIVE SEED,

APPLICATION RATE 20LBS/AC FERTILIZER: COMMERCIAL FERTILIZER, 10-20-20, 1,000 LBS./ACRE LIMING: 4,000 LBS./ACRE

MULCH: WHEAT OR OAT STRAW WELL CURED TO LESS THAN 20% MOISTURE BY WEIGHT, 5,800 POUNDS PER ACRE

SEEDING DATES: SPRING - MARCH TO MAY 30, FALL - SEPTEMBER 1 TO OCTOBER 15

PERMANENT-STEEP SLOPE

SEEDING DATES: APRIL-SEPT.

SPECIES: BIRDSFOOT TREFOIL AND TALL FESCUE MIX % PURE LIVE SEED: 99% APPLICATION RATE: 10 AND 50 LBS/ACRE. RESPECTIVELY FERTILIZER TYPE: COMMERCIAL FERTILIZER 5-10-10 FERTILIZER APPL. RATE: (PER TESTING) 30 LBS/ACRE LIMING RATE: 1 TONS/ACRE MULCH TYPE: HAY & STRAW MULCHING RATE: 3 TONS/ACRE ANCHORING MATERIAL: NONASPHALTIC MATERIAL ANCHORING METHOD: SPRAY RATE OF ANCHORING MATERIAL APPL.: 1000 GAL/SQ.YD.

IN PENNSYLVANIA

1-800-242-1776

PLANTING SCHEDULE							
LEGEND	KEY	QTY	BOTANICAL NAME	COMMON NAME	SIZE COND	REMARKS	HEIGHT SPREAD
	BUXMW	14	Buxus microphylla 'Wintergreen'	· · ·		Evergreen	4'-5' 3'-4'
		I	llov alabra	Danag Campgat	15"	Fuergroon	3'-4'
$\overline{(\cdot)}$	ILGD	28	llex glabra 'Densa'	Densa Compact Inkberry	B & B	Evergreen	4–5'
				,			
	CERC	8	Continus coggygria	Common Smoketree	6' B & B	Deciduous Clump Form	25'-30' 20'-25'
Can Nes							
000000000000000000000000000000000000000	PICG	5	Pinus strobus	Eastern White Pine	4' Ht. B & B	Evergreen	40'-60' 10'-20'
2000 2000 2000 2000							



CALL BEFORE YOU DIG Know what's below DESIGN SN: 20211762062 Call before you dig

THE GENERAL CONTRACTOR SHALL NOTIFY ALL UTILITY COMPANIES INVOLVED IN THE SITE NO MORE TEN DAYS AND NO LESS THAN THREE DAYS IN ADVANCE OF EXCAVATION (PA ACT 287 OF 1974 AMENDED BY ACT 50 OF 2018). PA STATE LAW REQUIRES 3 WORKING DAYS NOTICE

<u>LEGEND</u>

SAN - SANITARY ST - STORM MH — MANHOLE TOP - TOP OF CASTING INV - INVERT / FLOW LINE WATER VALVE GAS VALVE GAS METER ELECTRIC METER - STATE ROUTE

RCP - REINFORCED CONCRETE PIPE


CPP - CORRUGATED PLASTIC PIPE

TELE - TELEPHONE

——G—— – GAS LINE — T — - SUBSURFACE TELEPHONE LINE ——E — – SUBSURFACE ELECTRIC LINE -- 908 -- - EXISTING CONTOURS EXISTING INLET

—X——X— – FENCE

10' 20' EXISTING MANHOLE = = = = = = EXISTING SEWER

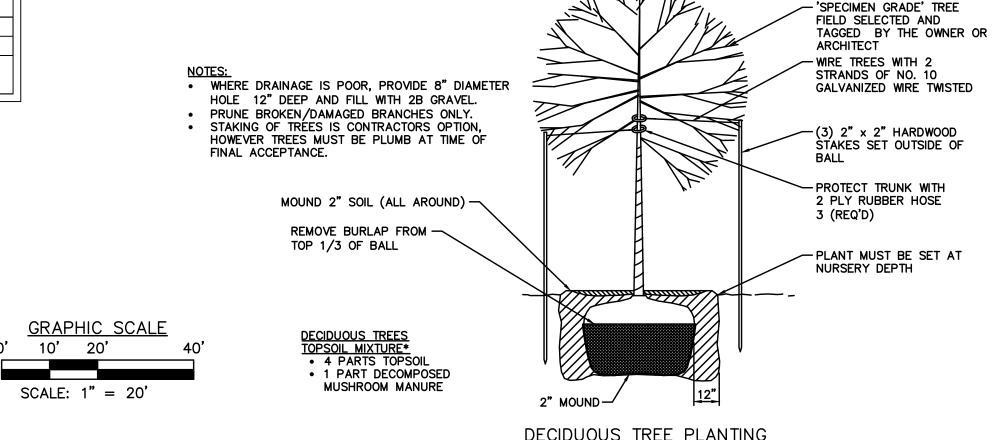

POINT OF

BEGINNING

SURVEYOR'S DESCRIPTION

RAFFIC POLF

THE ENGINEER ASSUMES NO RESPONSIBILITY FOR ANY CHANGES IN DESIGN PLANS UNLESS WRITTEN CONSENT IS GIVEN BY THE ENGINEER. THE CONTRACTOR AND/OR THE OWNER WILL BE HELD RESPONSIBLE FOR ANY FIELD MODIFICATIONS MADE WITHOUT THE WRITTEN CONSENT OF THE ENGINEER AND NECESSARY APPROVALS BY PERMITTING AGENCIES.

/N/F

GREEN RIDGE LEASING, LLC.

42-29-2454-365

(DEED N5671'35"W)


S55'27'51"E 208.33'


INS/TR. 202105697

15' BUILDING LINE PER PB 84, PG. 93

THE LOCATION OF EXISTING UTILITIES WERE TAKEN FROM RECORDS AND MARKING PROVIDED BY OTHERS AND OBSERVED EVIDENCE. THE LOCATIONS SHOWN MAY BE APPROXIMATE. THE CONTRACTOR IS RESPONSIBLE FOR DETERMINING THE EXACT LOCATIONS, SIZES AND DEPTH OF ALL UTILITIES PRIOR TO CONSTRUCTION. THE CONTRACTOR SHALL EXERCISE CARE TO AVOID DAMAGE TO ALL EXISTING UTILITIES.

© 2021 MORRIS KNOWLES & ASSOCIATES, INC. (A HAMMONTREE COMPANY) -THESE DRAWINGS SHALL NOT BE USED BY ANY PERSON, FIRM OR CORPORATION WITHOUT SPECIFIC WRITTEN PERMISSION FROM MORRIS KNOWLES & ASSOCIATES, INC. THESE PLANS ARE NOT TO BE REPRODUCED, CHANGED OR MANIPULATED IN ANY FORM OR MANNER WHATSOEVER, NOR ARE THEY TO BE ASSIGNED TO ANY THIRD PARTY WITHOUT PERMISSION AND CONSENT OF MORRIS KNOWLES & ASSOCIATES, INC.

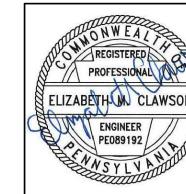

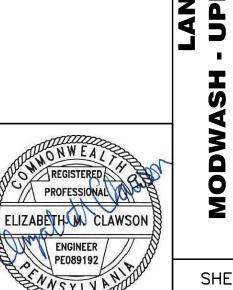

SHEET NO.


R R R R R R R


WED N BY NOV NOV

1"=20'

SCALE:

C500

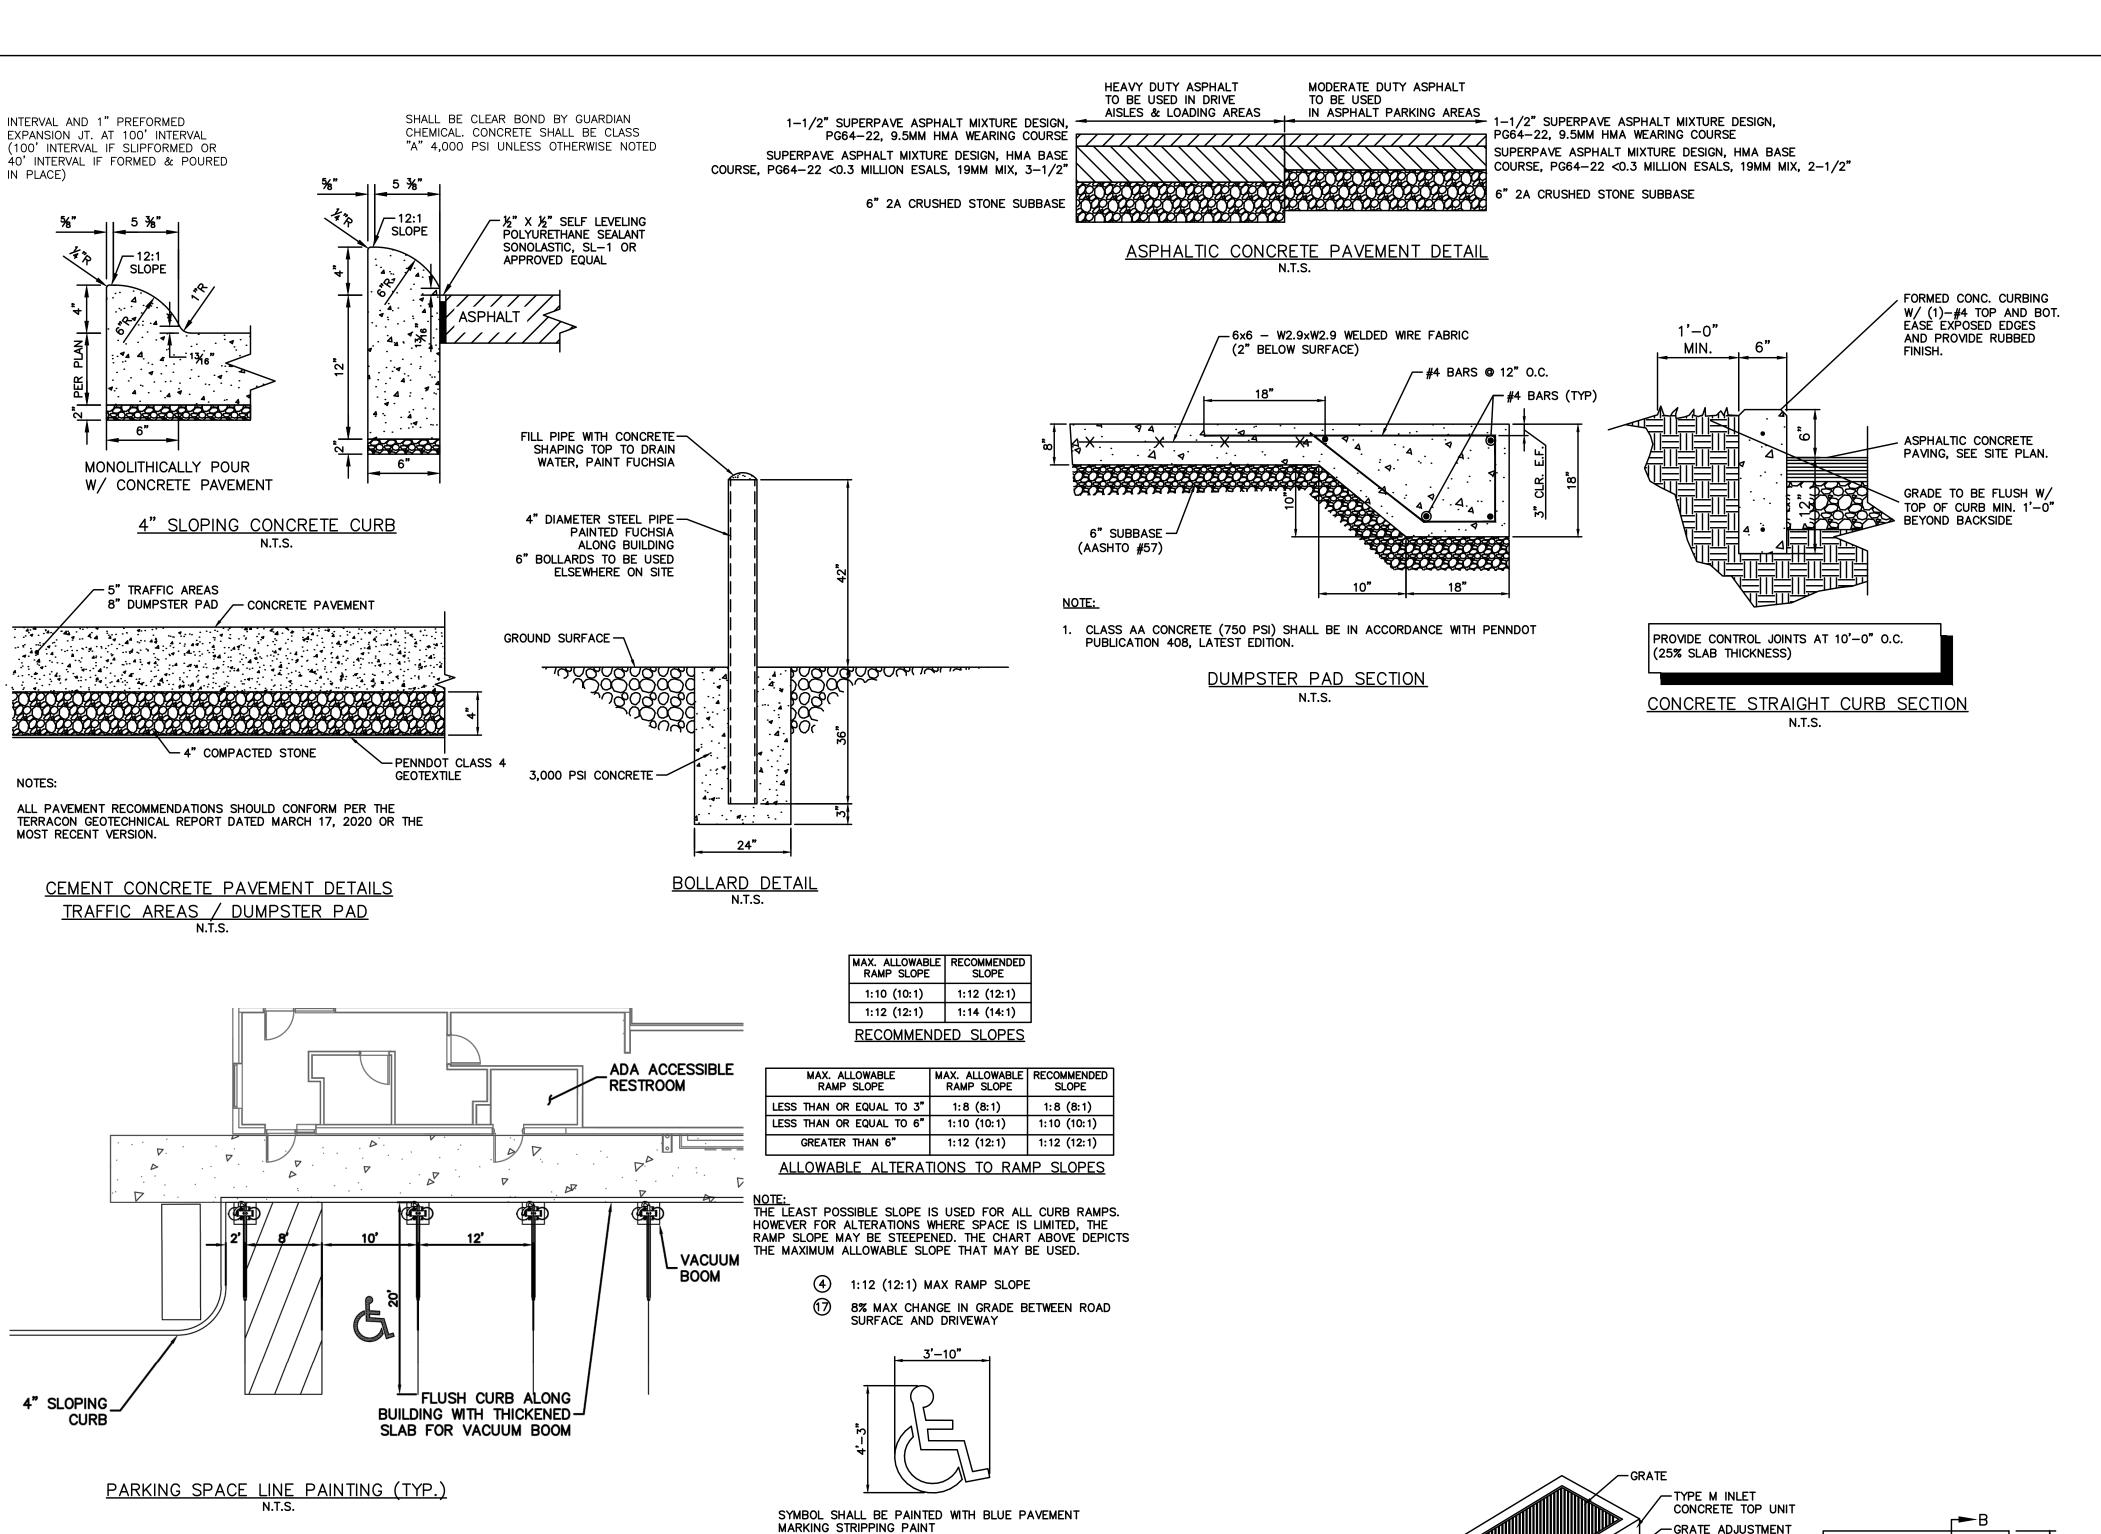

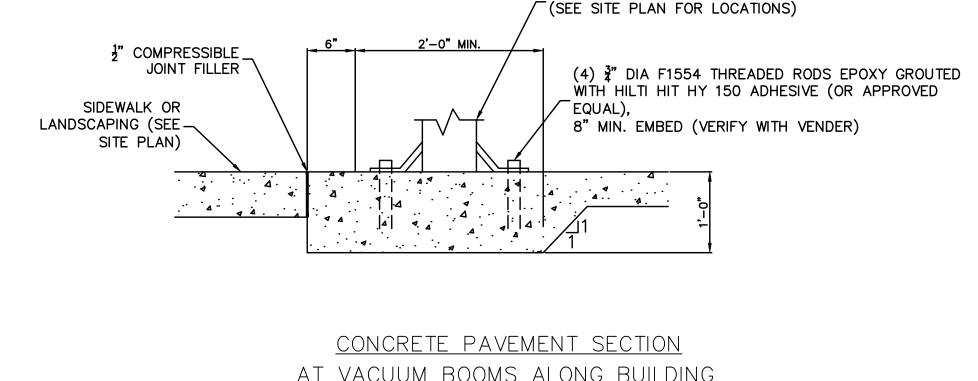


VACUUM POST BY OTHERS

AT VACUUM BOOMS ALONG BUILDING N.T.S.


NOTES:

- 1. CONTINUOUS THICKENED SLAB UNDER VACUUM BOOMS.
- 2. THIS DETAIL IS FOR THE LOCATION AND PAVEMENT DETAIL ONLY AND IS IN NO WAY INTENDED TO PROVIDE DETAILS ON STRUCTURAL SUPPORT. FOR STRUCTURAL SUPPORT SUCH AS REINFORCEMENT AND ANCHOR BOLTING, SEE STRUCTURAL PLANS BY OTHERS.

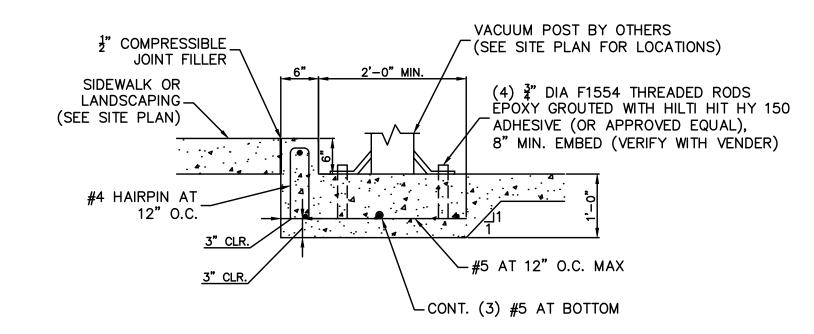


CONCRETE PAVEMENT SECTION AT VACUUM BOOMS N.T.S.

- 1. CONTINUOUS THICKENED SLAB UNDER VACUUM BOOMS.
- 2. THIS DETAIL IS FOR THE LOCATION AND PAVEMENT DETAIL ONLY AND IS IN NO WAY INTENDED TO PROVIDE DETAILS ON STRUCTURAL SUPPORT. FOR STRUCTURAL SUPPORT SUCH AS REINFORCEMENT AND ANCHOR BOLTING, SEE STRUCTURAL PLANS

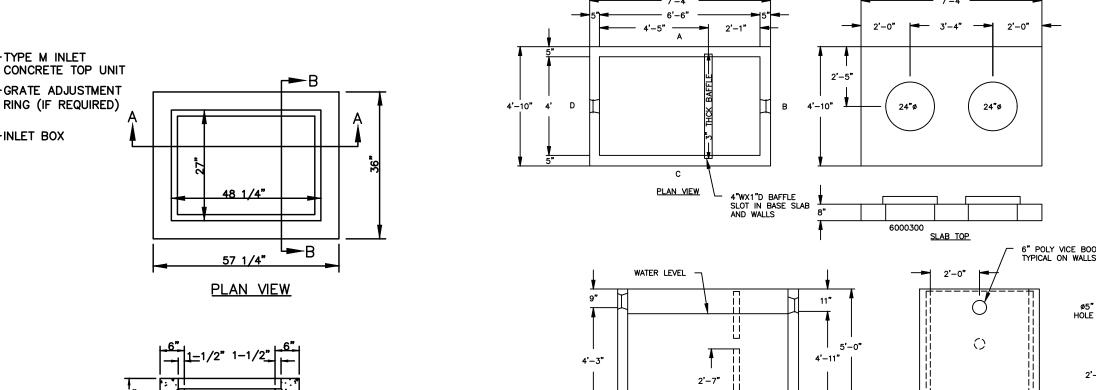

UNLESS WRITTEN CONSENT IS GIVEN BY THE ENGINEER. THE CONTRACTOR AND/OR THE OWNER WILL BE HELD RESPONSIBLE FOR ANY FIELD MODIFICATIONS MADE WITHOUT THE WRITTEN CONSENT OF THE ENGINEER AND NECESSARY APPROVALS BY PERMITTING AGENCIES.

© 2021 MORRIS KNOWLES & ASSOCIATES, INC. (A HAMMONTREE COMPANY) -THESE DRAWINGS SHALL NOT BE USED BY ANY PERSON, FIRM OR CORPORATION WITHOUT SPECIFIC WRITTEN PERMISSION FROM MORRIS KNOWLES & ASSOCIATES, INC. THESE PLANS ARE NOT TO BE REPRODUCED, CHANGED OR MANIPULATED IN ANY FORM OR MANNER WHATSOEVER, NOR ARE THEY TO BE ASSIGNED TO ANY THIRD

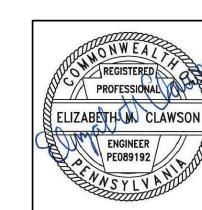

1. CONCRETE 28 DAY COMP. STRENGTH = 4,000

2. PRECAST STRUCTURES ARE PRODUCED TO MEET

3. SUPPORTS AN H20 LOADING AS INDICATED BY

AASHTO DESIGNED FDRO'-5" OF EARTH COVER.

OR EXCEED ASTM SPECIFICATIONS.

ELIZABETHUM CLAWSON


R R R R R R R

DAY BAY

SCALE:

N/A

7%<

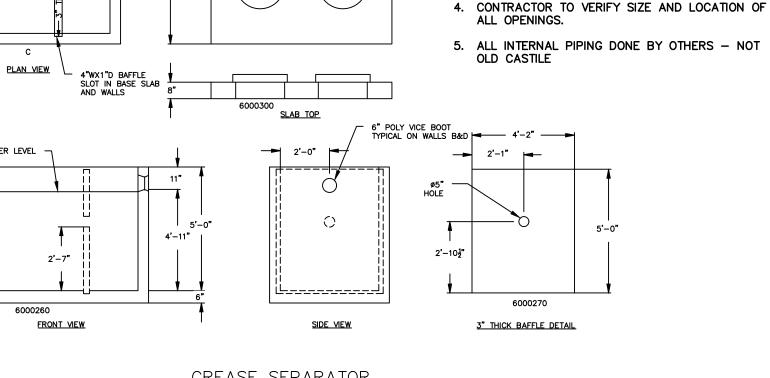

THE ENGINEER ASSUMES NO RESPONSIBILITY FOR ANY CHANGES IN DESIGN PLANS

THE LOCATION OF EXISTING UTILITIES WERE TAKEN FROM RECORDS AND MARKING PROVIDED BY OTHERS AND OBSERVED EVIDENCE. THE LOCATIONS SHOWN MAY BE APPROXIMATE. THE CONTRACTOR IS RESPONSIBLE FOR DETERMINING THE EXACT LOCATIONS, SIZES AND DEPTH OF ALL UTILITIES PRIOR TO CONSTRUCTION. THE CONTRACTOR SHALL EXERCISE CARE TO AVOID DAMAGE TO ALL EXISTING UTILITIES.

PARTY WITHOUT PERMISSION AND CONSENT OF MORRIS KNOWLES & ASSOCIATES, INC.

2'-0". PROVIDE WELDED WATERTIGHT CAP; PAINT F&L #6118, BLACK COFFEE. — PAINT PIPE BASE FUCHSIA. PAVEMENT #6-10" LONG BARS EACH WAY THROUGH PIPE. - 6" DIA. STD. STEEL PIPE FILLED WITH CONCRETE. '-2" DIA. CONCRETE BASE

- 1'-2"x1'-6"x.080 ALUMINUM

SIGN TO READ "RESERVED

HANDICAPPED PARKING SIGN.

PARKING" W/ IDENTIFICATION

W/ 3/8" CADIMUM PLATED BOLTS, NUTS & WASHERS.

(SIGNS ARE DOUBLE SIDED EXCEPT WHERE NOTED)

SYMBOL. BOLT TO STEEL TUBE

2"x2"x.188 STEEL TUBE EXTEND INTO CONCRETE FILLED PIPE

HANDICAP PARKING SIGN

PROVIDE MATERIALS AND CONSTRUCTION MEETING THE REQUIREMENTS OF PUBLICATION 408, SECTIONS 350, 409, 630, 676, 694, AND 695.

2. PROVIDE EXPANSION JOINT MATERIAL 13 (1/2") THICK WHERE CURB RAMP ADJOINS ANY RIGID PAVEMENT, SIDEWALK OR STRUCTURE WITH THE TOP OF JOINT FILLER FLUSH WITH ADJACENT CONCRETE SURFACE.

3. IF PEDESTRIAN CROSSWALKS ARE NOT WIDE ENOUGH TO PROVIDE MINIMUM 1220 X 1220 (4'-0" X 4'-0") WIDE WHEELCHAIR OVERRUN ZONE AT THE BOTTOM OF THE RAMP, POSITION CROSSWALKS AS INDICATED IN DETAIL A. ON SHEET 7.

4. SEAL JOINTS WITH AN APPROVED SEALING MATERIAL.

5. PROVIDE SLIP RESISTANT TEXTURE ON CURB RAMP BY COARSE BROOMING TRANSVERSE TO THE SLOPE OF THE RAMP. EXTEND TEXTURE THE FULL WIDTH AN LENGTH OF THE CURB RAMP INCLUDING FLARED SIDE

6. MODIFY CONSTRUCTION DETAILS TO ADAPT DIMENSIONS TO EXISTING CURB ALTERATIONS WHERE THE CURB IS LESS THAN THE STANDARD 200 (8") HEIGHT.

7. CURB RAMP AND SIDE FLARE LENGTHS ARE VARIABLE AND BASED ON CURB HEIGHT AND THE SIDEWALK

8. IT MAY BE NECESSARY TO LIMIT THE RUN OF PARALLEL OR PERPENDICULAR RAMP IN ORDER TO AVOID CHASING GRADE INDEFINITELY. RAMP LENGTH NOT TO EXCEED 15'-0", ADJUST RAMP SLOPE AS NEEDED.

9. MEASURE AND PAY FOR DEPRESSED CURB IN ACCORDANCE WITH SECTION 630.4.

10. WHENEVER POSSIBLE, CONSTRUCT THE TRANSITION SLOPE FROM THE CURB RAMP AND FLARE SIDES TO ADJOINING SURFACES WITH A GRADUAL ROUNDED SHAPE RATHER THAN AN ABRUPT ANGLE. ENSURE CONSTRUCTION IS WITHIN MAXIMUM SLOPE.

11. CONSTRUCT BUILT-UP CURB RAMP OF BITUMINOUS MATERIAL AS INDICATED, INCLUDING SURFACE PREPARATION AND TACK COAT, AS REQUIRED.

12. ALL DIMENSIONS ARE IN MILLIMETERS UNLESS OTHERWISE NOTED. US CUSTOMARY UNITS IN () PARENTHESIS.

13. ALIGN DETECTABLE WARNING DOMES ON A SQUARE GRID IN THE PREDOMINANT DIRECTION OF PEDESTRIAN 14. PROVIDE DETECTABLE WARNING SURFACES THAT CONTRAST VISUALLY WITH ADJACENT WALKWAY SURFACES,

EITHER LIGHT-ON-DARK OR DARK-ON-LIGHT FOR THE FULL WIDTH OF THE RAMP. 15. NOWHERE SHALL THE CROSS SLOPE OF THE RAMPS ACCESSIBLE ROUTE EXCEED 2%.

16. CONSTRUCT RAMP AND FLARE SLOPES WITH THE FLATTEST SLOPE POSSIBLE. THE SLOPES INDICATED IN THE DETAILS SHOW THE MAX SLOPE ALLOWABLE. IT IS STRONGLY RECOMMENDED TO USE THE FOLLOWING SLOPES TO ALLOW FOR CONSTRUCTION TOLERANCES.

BOTH WAYS

TOP SECTION B-B

BOX SECTION B-B


__2-1/2"


45-1/4"

TOP SECTION A-A

BOX SECTION A-A


SHEET NO. C600

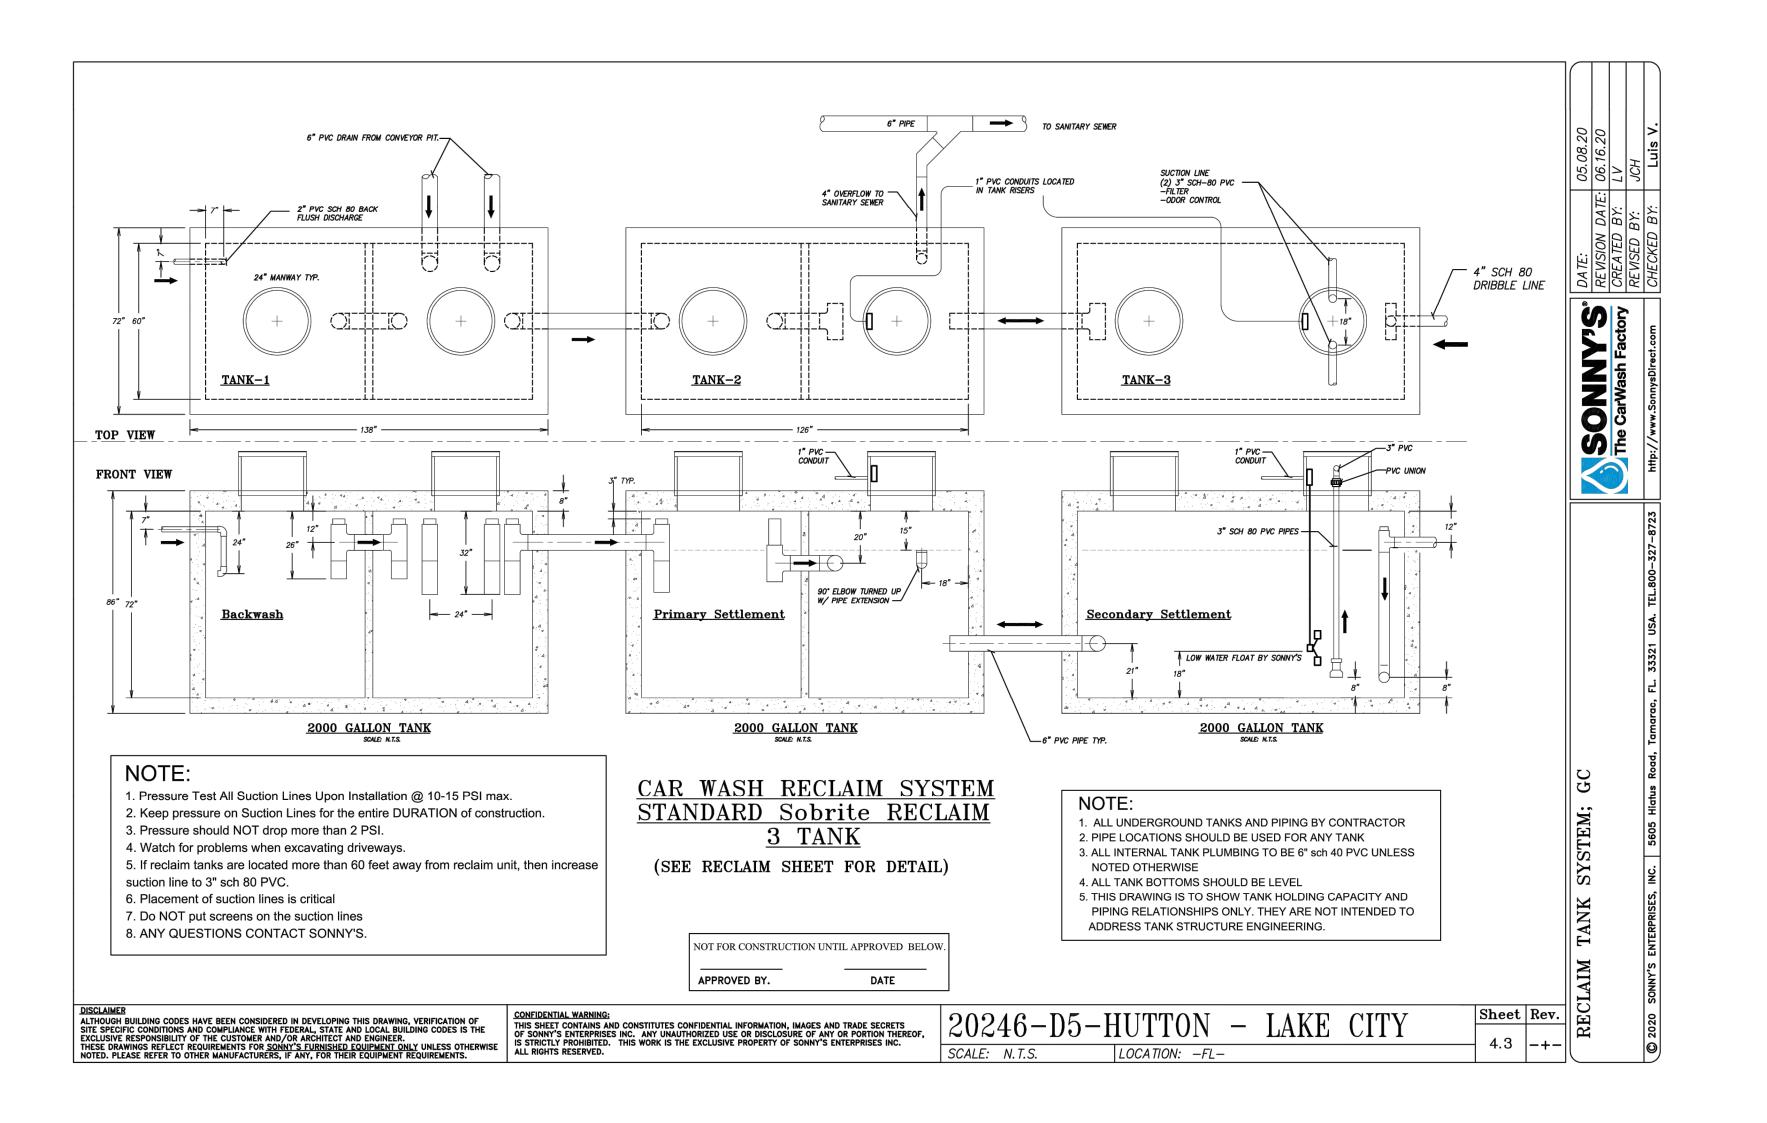

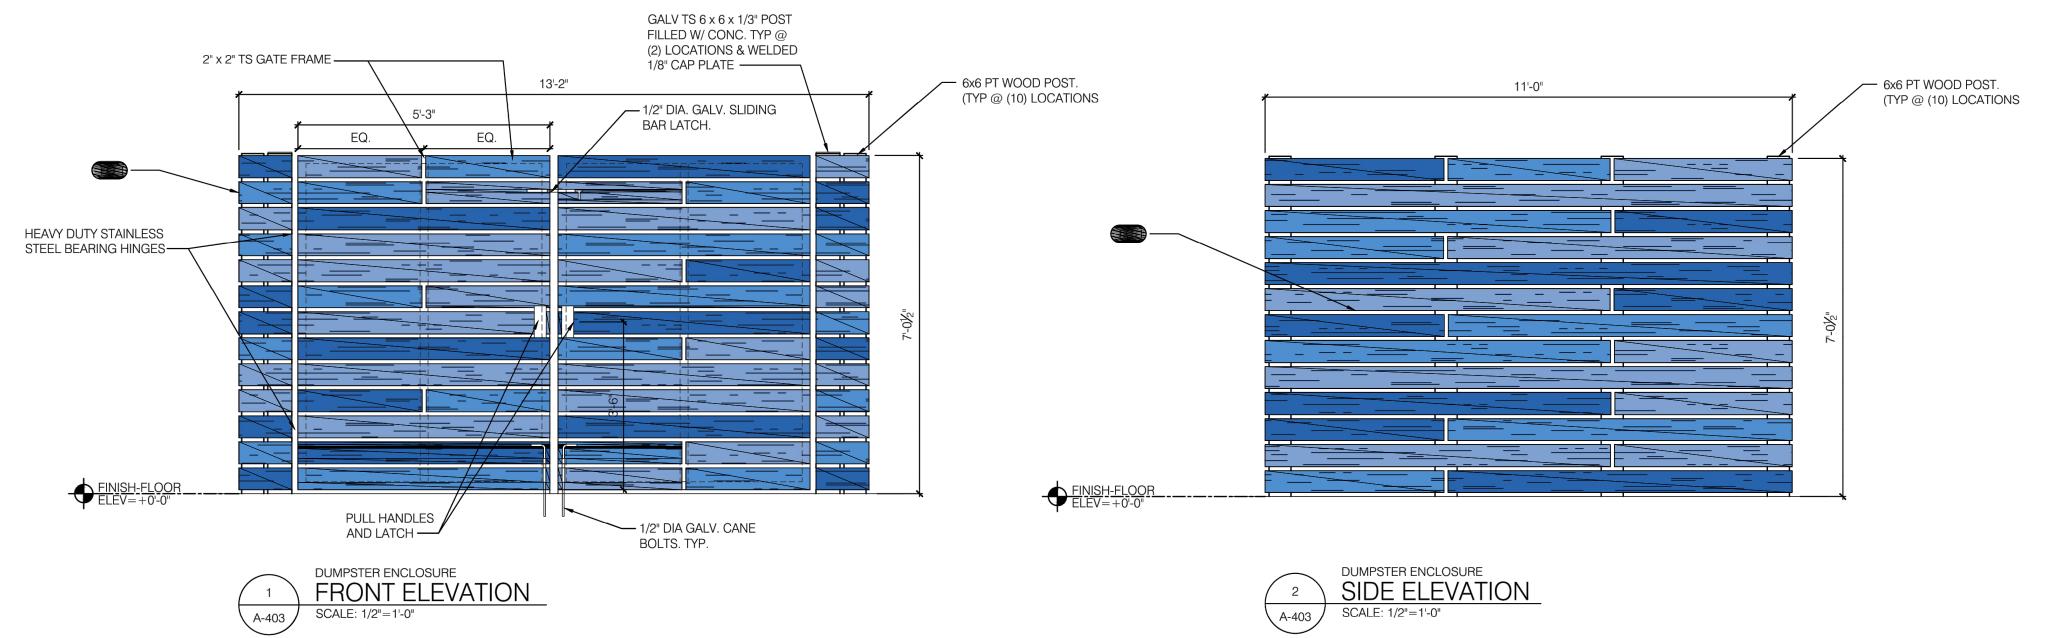


THE ENGINEER ASSUMES NO RESPONSIBILITY FOR ANY CHANGES IN DESIGN PLANS UNLESS WRITTEN CONSENT IS GIVEN BY THE ENGINEER. THE CONTRACTOR AND/OR THE OWNER WILL BE HELD RESPONSIBLE FOR ANY FIELD MODIFICATIONS MADE WITHOUT THE WRITTEN CONSENT OF THE ENGINEER AND NECESSARY APPROVALS BY PERMITTING AGENCIES.

THE LOCATION OF EXISTING UTILITIES WERE TAKEN FROM RECORDS AND MARKING PROVIDED BY OTHERS AND OBSERVED EVIDENCE. THE LOCATIONS SHOWN MAY BE APPROXIMATE. THE CONTRACTOR IS RESPONSIBLE FOR DETERMINING THE EXACT LOCATIONS, SIZES AND DEPTH OF ALL UTILITIES PRIOR TO CONSTRUCTION. THE CONTRACTOR SHALL EXERCISE CARE TO AVOID DAMAGE TO ALL EXISTING UTILITIES.

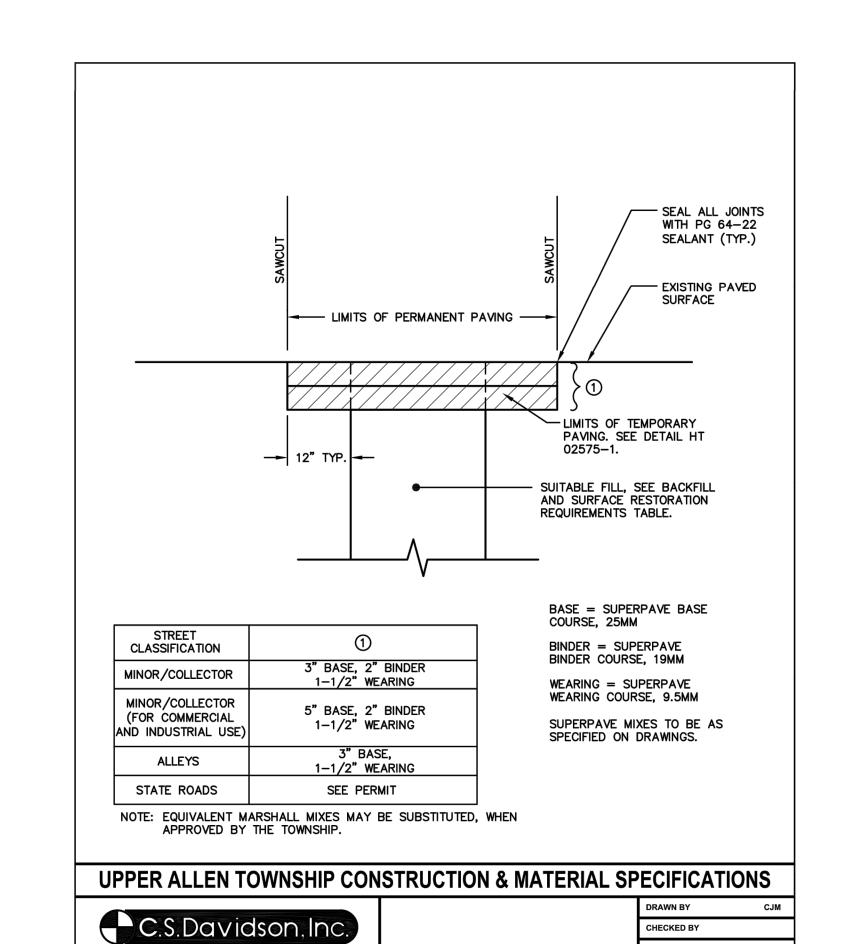

PERMANENT TRENCH PAVING

UPPER ALLEN TWP. CUMBERLAND COUNTY, PENNSYLVANIA FILE NO.

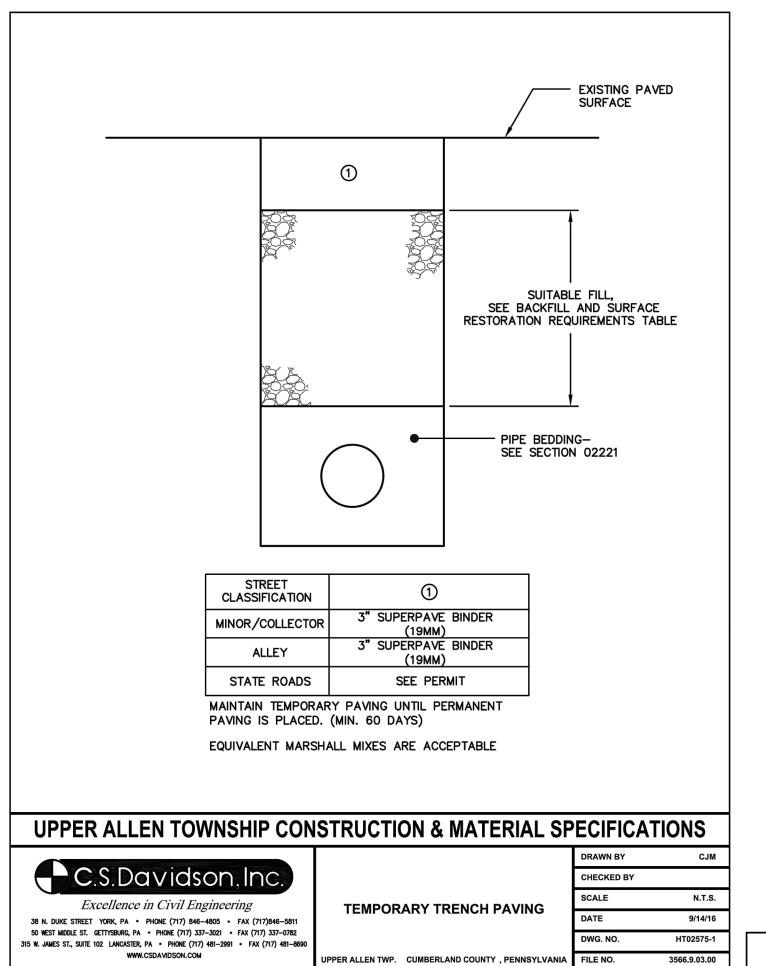


Excellence in Civil Engineering

38 N. DUKE STREET YORK, PA • PHONE (717) 846-4805 • FAX (717)846-5811 50 WEST MIDDLE ST. GETTYSBURG, PA • PHONE (717) 337-3021 • FAX (717) 337-0782 315 W. JAMES ST., SUITE 102 LANCASTER, PA • PHONE (717) 481-2991 • FAX (717) 481-869

WWW.CSDAVIDSON.COM

© 2021 MORRIS KNOWLES & ASSOCIATES, INC. (A HAMMONTREE COMPANY) -THESE DRAWINGS SHALL NOT BE USED BY ANY PERSON, FIRM OR CORPORATION WITHOUT SPECIFIC WRITTEN PERMISSION FROM MORRIS KNOWLES & ASSOCIATES, INC. THESE PLANS ARE NOT TO BE REPRODUCED, CHANGED OR MANIPULATED IN ANY FORM OR MANNER WHATSOEVER, NOR ARE THEY TO BE ASSIGNED TO ANY THIRD PARTY WITHOUT PERMISSION AND CONSENT OF MORRIS KNOWLES & ASSOCIATES, INC.

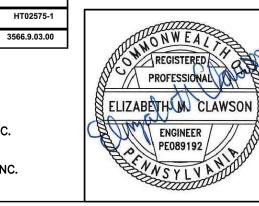

SHEET NO. C601

#######


DE DR DA PR

SCALE:

N/A

185


9/14/16

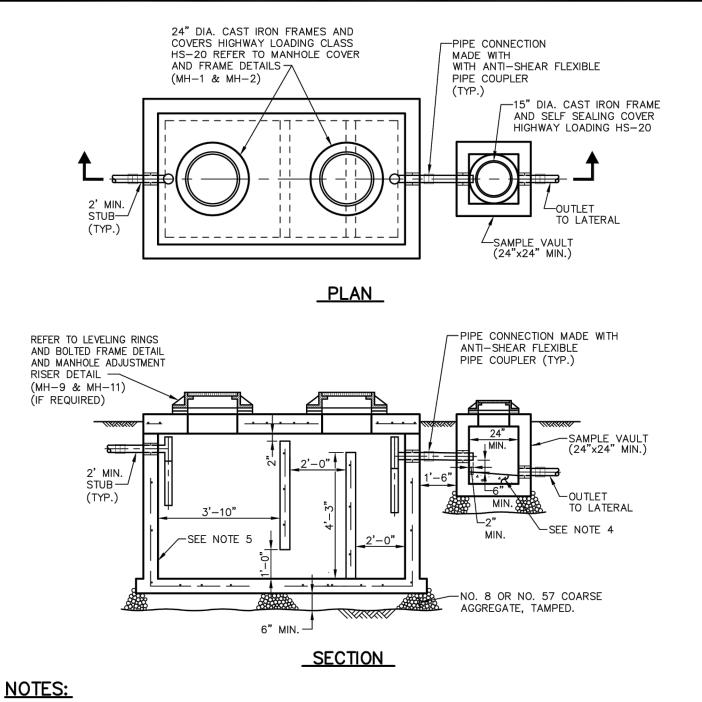



- 1. MINIMUM SIZE OF GREASE INTERCEPTOR PERMITTED IS 1,000 GALLONS, UNLESS OTHERWISE APPROVED IN WRITING BY TOWNSHIP ENGINEER.
- 2. GREASE INTERCEPTOR SIZE AND DESIGN SHALL COMPLY WITH SECTION 200-3.13, PARA. E, OF THE TOWNSHIP CODE.
- 3. ACCEPTABLE MANUFACTURERS: MONARCH PRODUCTS OR APPROVED EQUAL
- 4. CONCRETE FOR SLOPE TO BE 3,000 PSI MIX DESIGN MEETING SECTION 2601, PART 3.03, PARAGRAPH E OF THE STANDARD SPECIFICATIONS.
- 5. COAT ALL INTERIOR CONCRETE SURFACES WITH 100% SOLIDS EPOXY RESIN SYSTEM.


STANDARD DETAILS TYPICAL GREASE INTERCEPTOR AND SAMPLING VAULT UPPER ALLEN TOWNSHIP

FILE NAME: GR-1-GREASE-INT.DWG				
	DATE	REVISIONS		
	11/08	DWG. CREATED		
	11/14	GENERAL REVISIONS		
	1/17	NOTE REVISIONS		
	SCALE		DWG. NO.	
	NO SCALE		GR-1	

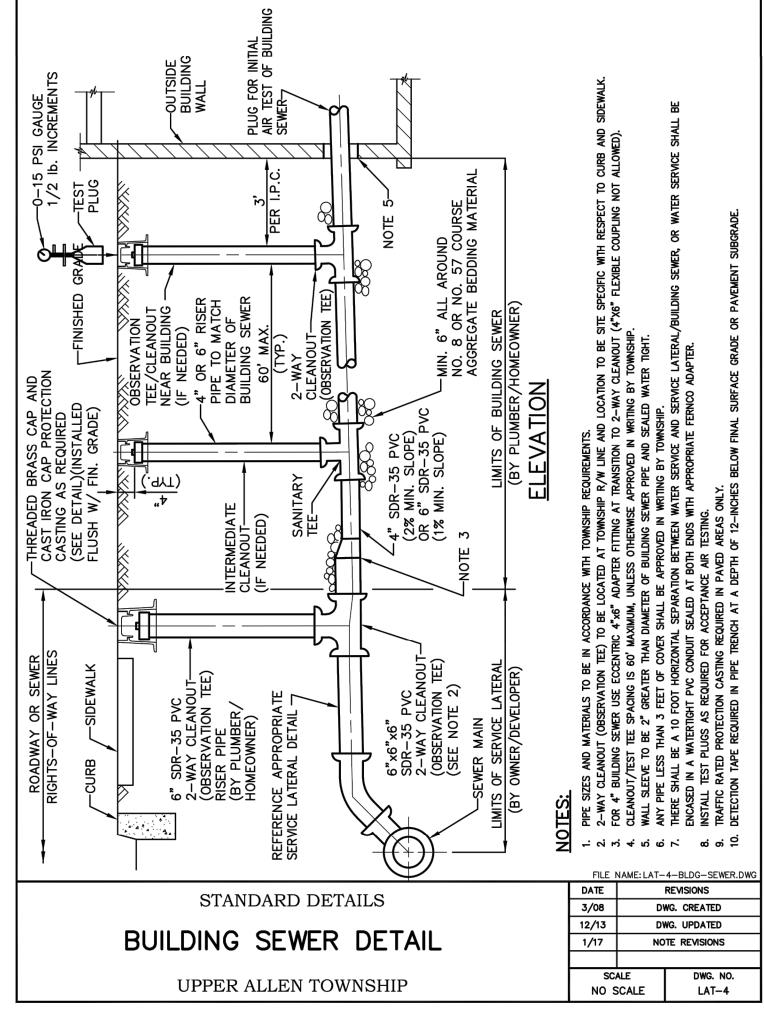

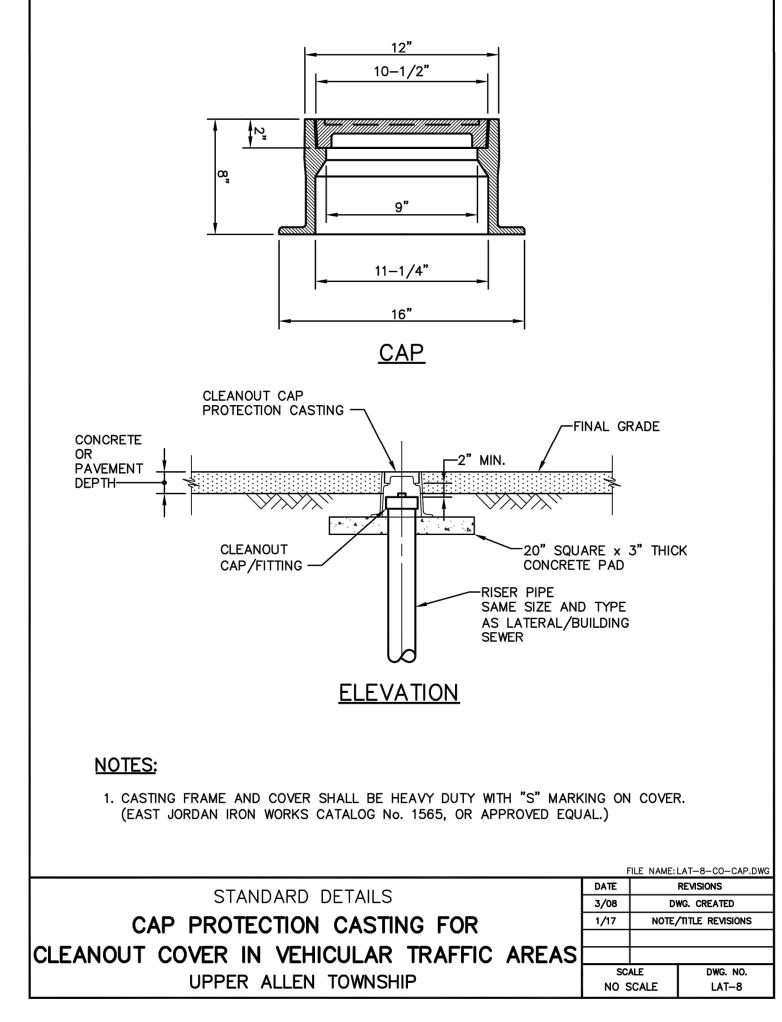

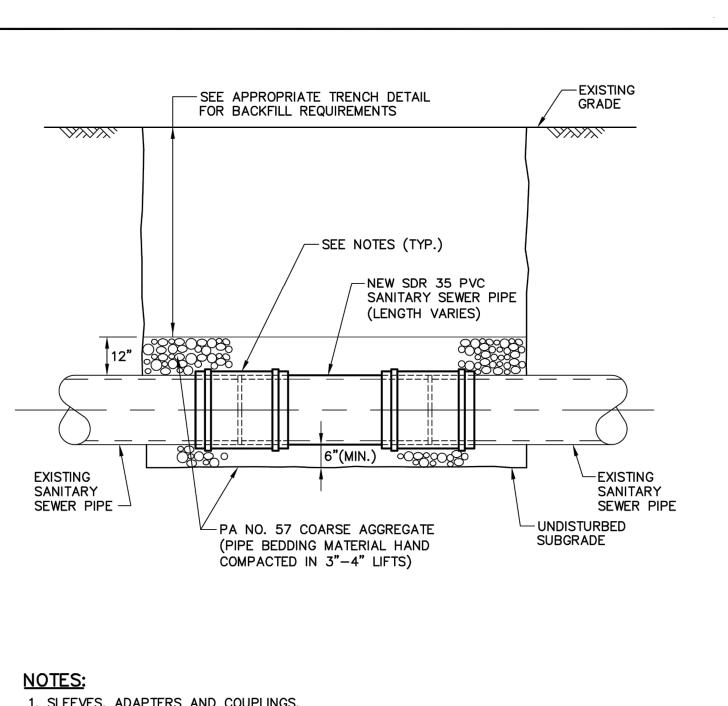

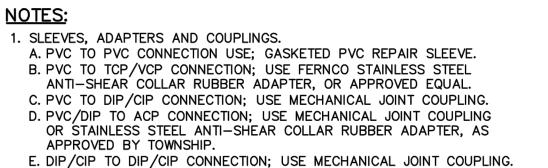

- 2. MECHANICAL JOINT COUPLINGS TO BE SMITH-BLAIR, DRESSER, OR
- APPROVED EQUAL. 3. RECONNECTIONS TO BE AIR TESTED IN ACCORDANCE WITH
- SPECIFICATIONS OR AS DIRECTED BY TOWNSHIP.


STANDARD DETAILS

PIPE REPAIR/RECONNECTION DETAIL

UPPER ALLEN TOWNSHIP

	DATE	REVISIONS		
	3/08	DWG. CREATED		
	12/09	GENERAL REVISIONS		
	12/13	DWG. UPDATED		
	1/17	NOTE REVISIONS		
	SC	ALE	DWG. NO.	
	NO SCALE		SEW-2	
<u> </u>				

FILE NAME: SEWER-2-PIPE-RECONNECTION.DWG

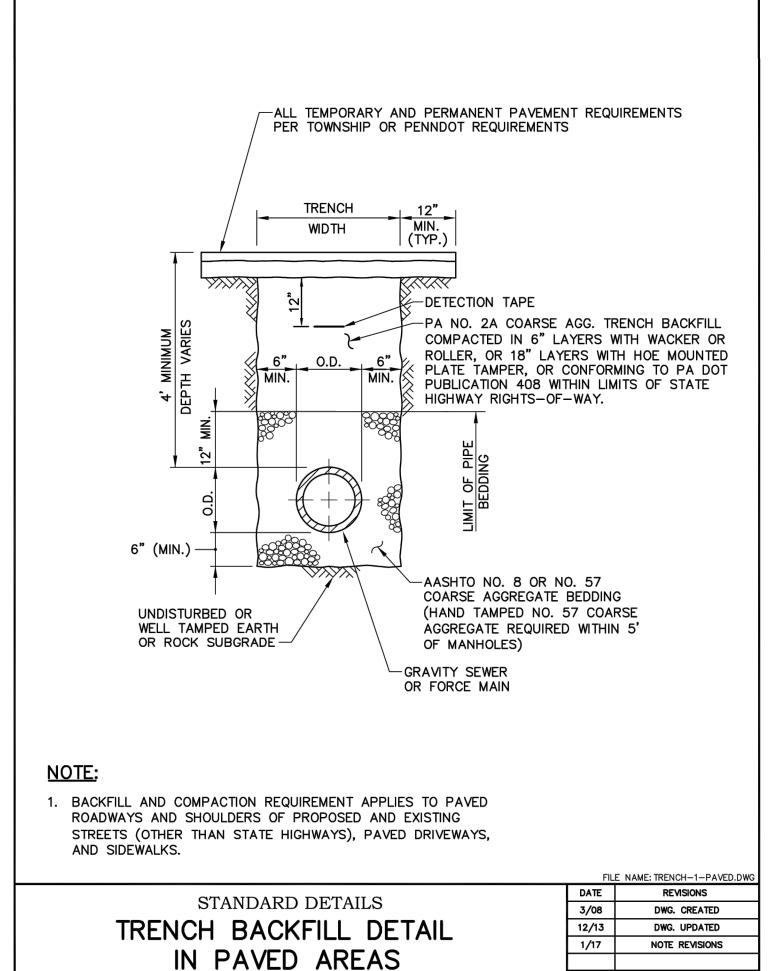


UPPER ALLEN TOWNSHIP


SCALE

NO SCALE

DWG. NO.

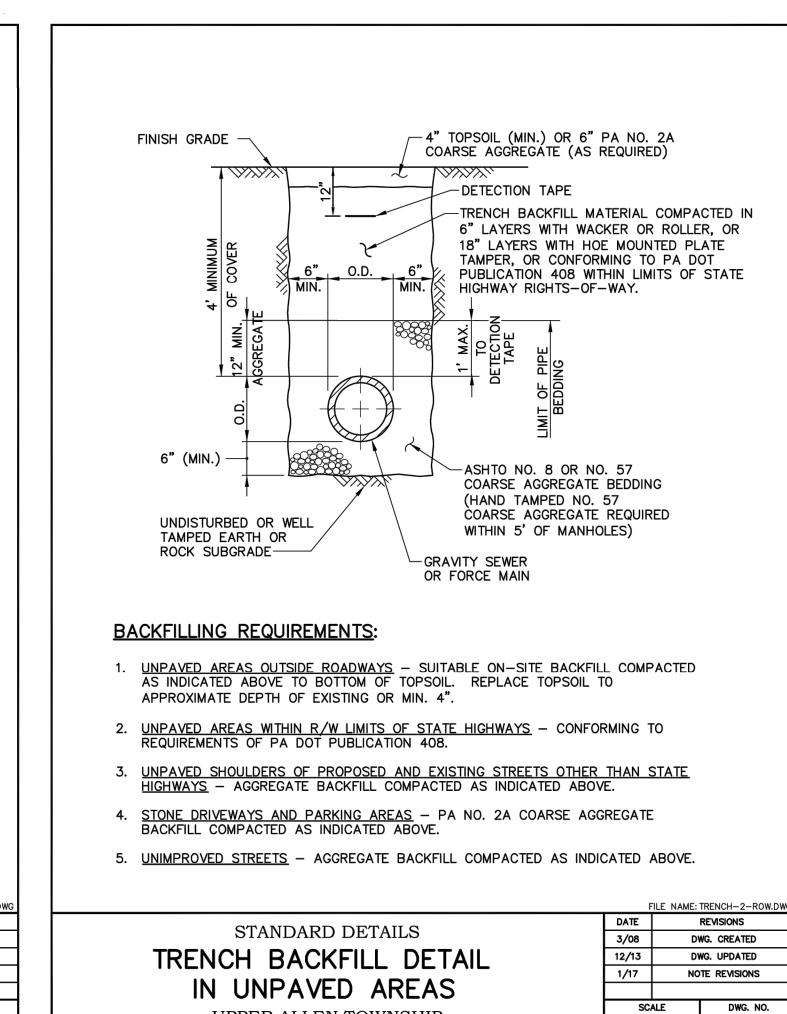

UPPER ALLEN TOWNSHIP

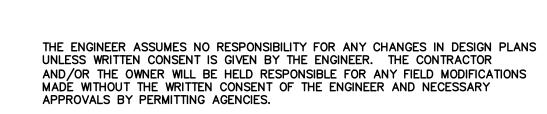

REVISIONS

DWG. CREATED


DWG. UPDATED

NOTE REVISIONS

NO SCALE

THE LOCATION OF EXISTING UTILITIES WERE TAKEN FROM RECORDS AND MARKING PROVIDED BY OTHERS AND OBSERVED EVIDENCE. THE LOCATIONS SHOWN MAY BE APPROXIMATE. THE CONTRACTOR IS RESPONSIBLE FOR DETERMINING THE EXACT LOCATIONS, SIZES AND DEPTH OF ALL UTILITIES PRIOR TO CONSTRUCTION. THE CONTRACTOR SHALL EXERCISE CARE TO AVOID DAMAGE TO ALL EXISTING UTILITIES.

© 2021 MORRIS KNOWLES & ASSOCIATES, INC. (A HAMMONTREE COMPANY) -THESE DRAWINGS SHALL NOT BE USED BY ANY PERSON, FIRM OR CORPORATION WITHOUT SPECIFIC WRITTEN PERMISSION FROM MORRIS KNOWLES & ASSOCIATES, INC. THESE PLANS ARE NOT TO BE REPRODUCED, CHANGED OR MANIPULATED IN ANY FORM OR MANNER WHATSOEVER, NOR ARE THEY TO BE ASSIGNED TO ANY THIRD PARTY WITHOUT PERMISSION AND CONSENT OF MORRIS KNOWLES & ASSOCIATES, INC. | ENGINEER | PE089192 /

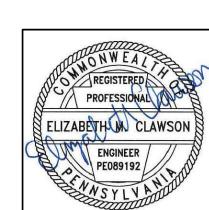

DAY BAY

> SCALE: N/A

185 0

SHEET NO. C602

SCALE: 1"=2000' USGS QUADRANGLE MAP LEMOYNE, PA

TITLE

C700 EROSION & SEDIMENTATION CONTROL TITLE SHEET EROSION & SEDIMENTATION CONTROL PLAN C701 C702 **EROSION & SEDIMENTATION CONTROL DETAILS**

HUTTON MECHANICSBURG PA ST, LLC 746 CHERRY STREET CHATTANOOGA, TN 37402 PHONE NO.: 404-805-0797 REP.: ALEJANDRO QUINTANA

CHAPTER 93 RECEIVING WATER COURSE:

1. THE RECEIVING WATER COURSE IS UNNAMED TRIBUTARY TO YELLOW BREECHES CREEK WHICH IS DESIGNATED AS A COLD WATER FISHERY (CWF), BY THE PENNSYLVANIA DEPARTMENT OF ENVIRONMENTAL PROTECTION, CHAPTER 93.

MODWASH-UPPER ALLEN TOWNSHIP

EROSION AND SEDIMENTATION CONTROL PLAN UPPER ALLEN TOWNSHIP, CUMBERLAND COUNTY, PENNSYLVANIA NOVEMBER 2021

CONSTRUCTION SEQUENCE:

THE ENTIRE SITE CANNOT BE CLEARED AND GRUBBED AT ONE TIME. ONLY AREAS FOR WHICH THE SPECIFIED EROSION AND SEDIMENTATION CONTROL HAS BEEN INSTALLED CAN BE CLEARED

STAGE 1: INSTALL ROCK CONSTRUCTION ENTRANCE AT KIM ACRES DRIVE A. CLEAR MINIMUM AREA NECESSARY FOR ENTRANCE INSTALLATION. EXCAVATE FOR AND FORM ENTRANCE. IMMEDIATELY STABILIZE ENTRANCE WITH ROCK.

STAGE 2: INSTALL INLET PROTECTION ON STORM SEWER INLETS A. CLEAN INLETS TO ENSURE PROPER STORMWATER FLOW THROUGH INLETS. 3. INSTALL INLET PROTECTION.

STAGE 3: INSTALL COMPOST FILTER SOCK A. INSTALL COMPOST FILTER SOCK PER PLAN ON C701.

STAGE 4: CLEAR SITE A. CLEAR SITE, CUT TRUNKS INTO TIMBER OR FIREWOOD AND CHIP BRANCHES ETC. LIMIT ADVANCED CLEARING AND GRUBBING AS MUCH AS POSSIBLE TO REDUCE THE AMOUNT OF AREA DISTURBED AT ANY ONE TIME. RECYCLING OF MATERIALS SHALL BE DONE WHERE

THE ENTIRE SITE CANNOT BE CLEARED AND GRUBBED AT ONE TIME. ONLY AREAS FOR WHICH THE SPECIFIED EROSION AND SEDIMENTATION CONTROL HAS BEEN INSTALLED CAN BE CLEARED AND GRUBBED OR DISTURBED.

STAGE 5: EXCAVATION

A. UPON COMPLETION OF THE ROCK CONSTRUCTION ENTRANCE AND INSTALLATION OF ALL PERIMETER CONTROLS, THE CONTRACTOR SHALL BEGIN EARTHMOVING ACTIVITIES. B. EXCAVATE SITE TO DESIGN GRADE. APPLY TEMPORARY STABILIZATION TO EMBANKMENTS AND FINISH GRADE AREAS IN CUT OR FILL.

C. PLACE EROSION CONTROL BLANKET AS NOTED ON PLANS AFTER MATERIAL IS PLACED AND D. ALL WATER PUMPED FROM WORK AREAS SHALL BE TREATED FOR SEDIMENT REMOVA

PRIOR TO DISCHARGING TO A SURFACE WATER. CONTRACTOR SHALL UTILIZE PUMPED WATER FILTER BAGS PER THE DETAIL ON PLAN SHEET C702 . AS SOON AS DISTURBED AREA REACHES FINAL GRADE, AREAS MUST BE STABILIZED. . NO MORE THAN 15,000 SQUARE FEET OF DISTURBED AREA SHALL REACH FINAL GRADE

BEFORE INITIATING SEED AND MULCHING OPERATIONS. G. FILL SLOPES SHALL BE STABILIZED IN 15 FOOT VERTICAL INCREMENTS.

STAGE 6: INSTALL PROPOSED STORM SEWER SYSTEM A. INSTALL STORM SEWER SYSTEM FROM LOWEST TO HIGHEST ELEVATION AND ADHERE TO

UTILITY TRENCH GUIDELINES. B. INSTALL INLET PROTECTION ON ALL INLETS TRIBUTARY TO INFILTRATION SYSTEMS UNTIL THE ENTIRE SITE HAS BEEN STABILIZED.

STAGE 7: INSTALL PROPOSED UTILITIES A. INSTALL UTILITIES FROM LOWEST TO HIGHEST ELEVATION AND ADHERE TO UTILITY TRENCH

STAGE 8: INSTALL BUILDINGS AND PAVEMENT

A. INSTALL CONCRETE WASHOUT AS INDICATED ON PLAN SHEET C701. . INSTALL PAVEMENT AT DRIVEWAYS AND PARKING LOT.

STAGE 9: INSTALL LANDSCAPING

A. INSTALL LANDSCAPING PLANTS AND PROVISIONS. STAGE 10: SEED AND MULCH

A. SEED/MULCH ALL DISTURBED AREAS WITH SPECIFIED SEEDING MIXTURE. ALL E & S CONTROL FACILITIES SHALL BE MAINTAINED AND KEPT FUNCTIONAL UNTIL SITE STABILIZATION IS COMPLETE.

D. INSTALL SIDEWALKS.

STAGE 11: SITE STABILIZATION A. IMMEDIATELY AFTER EARTH DISTURBANCE ACTIVITIES CEASE IN ANY AREA OR SUBAREA OF THE PROJECT, THE OPERATOR SHALL STABILIZE DISTURBED AREAS. AREAS NOT AS FINISHED GRADE. WHICH WILL BE REACTIVATED WITHIN 1 YEAR. MAY BE STABILIZED IN ACCORDANCE WITH THE TEMPORARY STABILIZATION SPECIFICATIONS. THOSE AREAS WHICH WILL NOT BE REACTIVATED WITHIN 1 YEAR, SHALL BE STABILIZED IN ACCORDANCE WITH

THE PERMANENT STABILIZATION SPECIFICATIONS. B. WHEN SEDIMENT TRAP AREA IS STABILIZED WITH UNIFORM 70% PERENNIAL VEGETATIVE COVER OVER PROJECT AREA, REMOVE EROSION AND SEDIMENTATION CONTROLS.

EROSION AND SEDIMENTATION CONTROL PLAN NOTES:

1. ALL EARTH DISTURBANCES, INCLUDING CLEARING AND GRUBBING AS WELL AS CUTS AND FILLS SHALL BE DONE IN ACCORDANCE WITH THE APPROVED E&S PLAN. A COPY OF THE APPROVED DRAWINGS (STAMPED. SIGNED AND DATED BY THE REVIEWING AGENCY) MUST BE AVAILABLE AT THE PROJECT SITE AT ALL TIMES. THE REVIEWING AGENCY SHALL BE NOTIFIED OF ANY CHANGES TO THE APPROVED PLAN PRIOR TO IMPLEMENTATION OF THOSE CHANGES. THE REVIEWING AGENCY MAY REQUIRE A WRITTEN SUBMITTAL OF THOSE CHANGES FOR REVIEW AND APPROVAL AT ITS DISCRETION.

2. AT LEAST 7 DAYS PRIOR TO STARTING ANY EARTH DISTURBANCE ACTIVITIES, INCLUDING CLEARING AND GRUBBING, THE OWNER AND/OR OPERATOR SHALL INVITE ALL CONTRACTORS. THE LANDOWNER, APPROPRIATE MUNICIPAL OFFICIALS, THE E&S PLAN PREPARER. THE PCSM PLAN PREPARER, THE LICENSED PROFESSIONAL RESPONSIBLE FOR OVERSIGHT OF CRITICAL STAGES OF IMPLEMENTATION OF THE PCSM PLAN. AND A REPRESENTATIVE FROM THE LOCAL CONSERVATION DISTRICT TO AN ON-SITE

PRECONSTRUCTION MEETING. 3. AT LEAST 3 DAYS PRIOR TO STARTING ANY EARTH DISTURBANCE ACTIVITIES, OR EXPANDING INTO AN AREA PREVIOUSLY UNMARKED. THE PENNSYLVANIA ONE CALL SYSTEM INC. SHALL BE NOTIFIED AT 1-800-242-1776 FOR THE LOCATION OF EXISTING UNDERGROUND UTILITIES.

ALL EARTH DISTURBANCE ACTIVITIES SHALL PROCEED IN ACCORDANCE WITH THE SEQUENCE PROVIDED ON THE PLAN DRAWINGS. DEVIATION FROM THAT SEQUENCE MUST BE APPROVED IN WRITING FROM THE LOCAL CONSERVATION DISTRICT OR BY THE DEPARTMENT PRIOR TO IMPLEMENTATION. AREAS TO BE FILLED ARE TO BE CLEARED, GRUBBED, AND STRIPPED OF TOPSOIL TO

REMOVE TREES, VEGETATION, ROOTS AND OTHER OBJECTIONABLE MATERIAL. CLEARING, GRUBBING, AND TOPSOIL STRIPPING SHALL BE LIMITED TO THOSE AREAS DESCRIBED IN EACH STAGE OF THE CONSTRUCTION SEQUENCE. GENERAL SITE CLEARING, GRUBBING AND TOPSOIL STRIPPING MAY NOT COMMENCE IN ANY STAGE OR PHASE OF THE PROJECT UNTIL THE E&S BMPS SPECIFIED BY THE BMP SEQUENCE FOR THAT STAGE OR

PHASE HAVE BEEN INSTALLED AND ARE FUNCTIONING AS DESCRIBED IN THIS E&S PLAN. AT NO TIME SHALL CONSTRUCTION VEHICLES BE ALLOWED TO ENTER AREAS OUTSIDE THE LIMIT OF DISTURBANCE BOUNDARIES SHOWN ON THE PLAN MAPS. THESE AREAS MUST BE CLEARLY MARKED AND FENCED OFF BEFORE CLEARING AND GRUBBING OPERATIONS BEGIN. 8. TOPSOIL REQUIRED FOR THE ESTABLISHMENT OF VEGETATION SHALL BE STOCKPILED AT

COMPLETE THE FINISH GRADING OF ALL EXPOSÉD AREAS THAT ARE TO BE STABILIZED BY VEGETATION. EACH STOCKPILE SHALL BE PROTECTED IN THE MANNER SHOWN ON THE PLAN DRAWINGS. STOCKPILE HEIGHTS SHALL NOT EXCEED 35 FEET. STOCKPILE SLOPES SHALL BE 2H: 1V OR FLATTER. IMMEDIATELY UPON DISCOVERING UNFORESEEN CIRCUMSTANCES POSING THE POTENTIAL FOR ACCELERATED EROSION AND/OR SEDIMENT POLLUTION, THE OPERATOR SHALL

THE LOCATION(S) SHOWN ON THE PLAN MAP(S) IN THE AMOUNT NECESSARY TO

IMPLEMENT APPROPRIATE BEST MANAGEMENT PRACTICES TO MINIMIZE THE POTENTIAL FOR EROSION AND SEDIMENT POLLUTION AND NOTIFY THE LOCAL CONSERVATION DISTRICT AND/OR THE REGIONAL OFFICE OF THE DEPARTMENT. 10. ALL BUILDING MATERIALS AND WASTES SHALL BE REMOVED FROM THE SITE AND

RECYCLED OR DISPOSED OF IN ACCORDANCE WITH THE DEPARTMENT'S SOLID WASTE MANAGEMENT REGULATIONS AT 25 PA. CODE 260.1 ET. SEQ., 271.1, AND 287.1 ET. SEQ. NO BUILDING MATERIALS OR WASTES OR UNUSED BUILDING MATERIALS SHALL BE BURNED, BURIED, DUMPED, OR DISCHARGED AT THE SITE. 11. ALL OFF-SITE WASTE AND BORROW AREAS MUST HAVE AN E&S PLAN APPROVED BY THE

LOCAL CONSERVATION DISTRICT OR THE DEPARTMENT FULLY IMPLEMENTED PRIOR TO BEING ACTIVATED. 12. THE CONTRACTOR IS RESPONSIBLE FOR ENSURING THAT ANY MATERIAL BROUGHT ON SITE IS CLEAN FILL. FORM FP-001 MUST BE RETAINED BY THE PROPERTY OWNER FOR ANY

FILL MATERIAL AFFECTED BY A SPILL OR RELEASE OF A REGULATED SUBSTANCE BUT QUALIFYING AS CLEAN FILL DUE TO ANALYTICAL TESTING. 13. ALL PUMPING OF WATER FROM ANY WORK AREA SHALL BE DONE ACCORDING TO THE

PROCEDURE DESCRIBED IN THIS PLAN, OVER UNDISTURBED VEGETATED AREAS.

14. VEHICLES AND EQUIPMENT MAY ENTER DIRECTLY ONTO KIM ACRES DRIVE 15. UNTIL THE SITE IS STABILIZED, ALL EROSION AND SEDIMENT BMPS SHALL BE MAINTAINED PROPERLY MAINTENANCE SHALL INCLUDE INSPECTIONS OF ALL EROSION AND SEDIMENT BMPS AFTER EACH RUNOFF EVENT AND ON A WEEKLY BASIS. ALL PREVENTATIVE AND REMEDIAL MAINTENANCE WORK, INCLUDING CLEAN OUT, REPAIR, REPLACEMENT, REGRADING, RESEEDING, REMULCHING AND RENETTING MUST BE PERFORMED IMMEDIATELY. IF THE E&S BMPS FAIL TO PERFORM AS EXPECTED, REPLACEMENT BMPS, OR MODIFICATIONS OF THOSE INSTALLED WILL BE REQUIRED.

16. A LOG SHOWING DATES THAT E&S BMPS WERE INSPECTED AS WELL AS ANY DEFICIENCIES FOUND AND THE DATE THEY WERE CORRECTED SHALL BE MAINTAINED ON THE SITE AND BE MADE AVAILABLE TO REGULATORY AGENCY OFFICIALS AT THE TIME OF INSPECTION. INSPECTIONS SHALL BE LOGGED ON THE MOST CURRENT DEP FORM 3150-FM-BWEW0083 AND KEPT ON SITE AT ALL TIMES.

17. SEDIMENT TRACKED ONTO ANY PUBLIC ROADWAY OR SIDEWALK SHALL BE RETURNED TO THE CONSTRUCTION SITE BY THE END OF EACH WORK DAY AND DISPOSED OF IN THE MANNER DESCRIBED IN THIS PLAN. IN NO CASE SHALL THE SEDIMENT BE WASHED, SHOVELED, OR SWEPT INTO ANY ROADSIDE DITCH, STORM SEWER, OR SURFACE WATER. 18. ALL SEDIMENT REMOVED FROM BMPS SHALL BE DISPOSED OF IN THE MANNER DESCRIBED

ON THE PLAN DRAWINGS. 19. AREAS WHICH ARE TO BE TOPSOILED SHALL BE SCARIFIED TO A MINIMUM DEPTH OF 3 TO 5 INCHES - 6 TO 12 INCHES ON COMPACTED SOILS - PRIOR TO PLACEMENT OF TOPSOIL. AREAS TO BE VEGETATED SHALL HAVE A MINIMUM 4 INCHES OF TOPSOIL IN PLACE PRIOR TO SEEDING AND MULCHING. FILL OUTSLOPES SHALL HAVE A MINIMUM 2 INCHES OF

20. ALL FILLS SHALL BE COMPACTED AS REQUIRED TO REDUCE EROSION, SLIPPAGE, SETTLEMENT, SUBSIDENCE OR OTHER RELATED PROBLEMS. FILL INTENDED TO SUPPORT BUILDINGS, STRUCTURES AND CONDUITS, ETC. SHALL BE COMPACTED IN ACCORDANCE

WITH LOCAL REQUIREMENTS OR CODES. 21. ALL EARTHEN FILLS SHALL BE PLACED IN COMPACTED LAYERS NOT TO EXCEED 9 INCHES 22. FILL MATERIALS SHALL BE FREE OF FROZEN PARTICLES, BRUSH, ROOTS, SOD, OR OTHER

FOREIGN OR OBJECTIONABLE MATERIALS THAT WOULD INTERFERE WITH OR PREVENT CONSTRUCTION OF SATISFACTORY FILLS. 23. FROZEN MATERIALS OR SOFT, MUCKY, OR HIGHLY COMPRESSIBLE MATERIALS SHALL NOT BE INCORPORATED INTO FILLS.

24. FILL SHALL NOT BE PLACED ON SATURATED OR FROZEN SURFACES. 25. SEEPS OR SPRINGS ENCOUNTERED DURING CONSTRUCTION SHALL BE HANDLED IN ACCORDANCE WITH THE STANDARD AND SPECIFICATIONS FOR SUBSURFACE DRAIN OR

OTHER APPROVED METHOD. 26. ALL GRADED AREAS SHALL BE PERMANENTLY STABILIZED IMMEDIATELY UPON REACHING FINISHED GRADE. CUT SLOPES IN COMPETENT BEDROCK AND ROCK FILLS NEED NOT BE VEGETATED. SEEDED AREAS WITHIN 50 FEET OF A SURFACE WATER, OR AS OTHERWISE SHOWN ON THE PLAN DRAWINGS, SHALL BE BLANKETED ACCORDING TO THE STANDARDS

27. IMMEDIATELY AFTER EARTH DISTURBANCE ACTIVITIES CEASE IN ANY AREA OR SUBAREA OF A PROJECT, THE OPERATOR SHALL STABILIZE ALL DISTURBED AREAS. DURING NON-GERMINATEING MONTHS. MULCH OR PROTECTIVE BLANKETING SHALL BE APPLIED AS DESCRIBED IN THE PLAN. AREAS NOT AT FINISHED GRADE, WHICH WILL BE REACTIVATED WITHIN 1 YEAR, MAY BE STABILIZED IN ACCORDANCE WITH THE TEMPORARY STABILIZATION SPECIFICATIONS. THOSE AREAS WHICH WILL NOT BE REACTIVATED WITHIN 1 YEAR SHALL BE STABILIZED IN ACCORDANCE WITH THE PERMANENT STABILIZATION SPECIFICATIONS.

28. PERMANENT STABILIZATION IS DEFINED AS A MINIMUM UNIFORM, PERENNIAL 70% VEGETATIVE COVER OR OTHER PERMANENT NON-VEGETATIVE COVER WITH A DENSITY SUFFICIENT TO RESIST ACCELERATED EROSION. CUT AND FILL SLOPES SHALL BE CAPABLE OF RESISTING FAILURE DUE TO SLUMPING, SLIDING, OR OTHER MOVEMENTS. 29. E&S BMPS SHALL REMAIN FUNCTIONAL AS SUCH UNTIL ALL AREAS TRIBUTARY TO THEM

ARE PERMANENTLY STABILIZED OR UNTIL THEY ARE REPLACED BY ANOTHER BMP APPROVED BY THE LOCAL CONSERVATION DISTRICT OR THE DEPARTMENT.

30. UPON COMPLETION OF ALL EARTH DISTURBANCE ACTIVITIES AND PERMANENT STABILIZATION OF ALL DISTURBED AREAS, THE OWNER AND/OR OPERATOR SHALL CONTACT THE LOCAL CONSERVATION DISTRICT FOR AN INSPECTION PRIOR TO REMOVAL CONVERSION OF THE E&S BMPS.

31. AFTER FINAL SITE STABILIZATION HAS BEEN ACHIEVED, TEMPORARY EROSION AND SEDIMENT BMPS MUST BE REMOVED OR CONVERTED TO PERMANENT POST CONSTRUCTION STORMWATER MANAGEMENT BMPS. AREAS DISTURBED DURING REMOVAL OR CONVERSION OF THE BMPS SHALL BE STABILIZED IMMEDIATELY. IN ORDER TO ENSURE RAPID

REVEGETATION OF DISTURBED AREAS, SUCH REMOVAL/CONVERSIONS ARE TO BE DONE ONLY DURING THE GERMINATING SEASON. 32. UPON COMPLETION OF ALL EARTH DISTURBANCE ACTIVITIES AND PERMANENT STABILIZATION OF ALL DISTURBED AREAS, THE OWNER AND/OR OPERATOR SHALL

CONTACT THE LOCAL CONSERVATION DISTRICT TO SCHEDULE A FINAL INSPECTION. 33. FAILURE TO CORRECTLY INSTALL E&S BMPS, FAILURE TO PREVENT SEDIMENT-LADEN RUNOFF FROM LEAVING THE CONSTRUCTION SITE, OR FAILURE TO TAKE IMMEDIATE CORRECTIVE ACTION TO RESOLVE FAILURE OF E&S BMPS MAY RESULT IN ADMINISTRATIVE CIVIL, AND/OR CRIMINAL PENALTIES BEING INSTITUTED BY THE DEPARTMENT AS DEFINED IN SECTION 602 OF THE PENNSYLVANIA CLEAN STREAMS LAW. THE CLEAN STREAMS LAW PROVIDES PROVIDES FOR UP TO \$10,000 PER DAY IN CIVIL PENALTIES, UP TO \$10,000 IN SUMMARY CRIMINAL PENALTIES, AND UP TO \$25,000 IN MISDEMEANOR CRIMINAL PENALTIES FOR EACH VIOLATION.

34. CONCRETE WASH WATER SHALL BE HANDLED IN THE MANNER DESCRIBED ON THE PLAN DRAWINGS. IN NO CASE SHALL IT BE ALLOWED TO ENTER ANY SURFACE WATERS OR

GROUNDWATER SYSTEMS 35. ALL CHANNELS SHALL BE KEPT FREE OF OBSTRUCTIONS INCLUDING BUT NOT LIMITED TO FILL, ROCKS, LEAVES, WOODY DEBRIS, ACCUMULATED SEDIMENT, EXCESS VEGETATION, AND CONSTRUCTION MATERIAL/WASTES.

36. UNDERGROUND UTILITIES CUTTING THROUGH ANY ACTIVE CHANNEL SHALL BE IMMEDIATEL' BACKFILLED AND THE CHANNEL RESTORED TO ITS ORIGINAL CROSS-SECTION AND PROTECTIVE LINING. ANY BASE FLOW WITHIN THE CHANNEL SHALL BE CONVEYED PAST THE WORK AREA IN THE MANNER DESCRIBED IN THIS PLAN UNTIL SUCH RESTORATION IS

OVER-EXCAVATED SO THAT THE DESIGN DIMENSIONS WILL BE PROVIDED AFTER PLACEMENT OF THE PROTECTIVE LINING. 38. SEDIMENT BASINS AND/OR TRAPS SHALL BE KEPT FREE OF ALL CONSTRUCTION WASTE, WASH WATER, AND OTHER DEBRIS HAVING POTENTIAL TO CLOG THE BASIN-TRAP OUTLET

37. CHANNELS HAVING RIPRAP, RENO MATTRESS, OR GABION LININGS MUST BE SUFFICIENTLY

STRUCTURES AND/OR POLLUTE THE SURFACE WATERS. 39. SEDIMENT BASINS SHALL BE PROTECTED FROM UNAUTHORIZED ACTS BY THIRD PARTIES. 40. ANY DAMAGE THAT OCCURS IN WHOLE OR IN PART AS A RESULT OF BASIN OR TRAP DISCHARGE SHALL BE IMMEDIATELY REPAIRED BY THE PERMITTEE IN A PERMANENT MANNER SATISFACTORY TO THE MUNICIPALITY, LOCAL CONSERVATION DISTRICT, AND THE

OWNER OF THE DAMAGED PROPERTY. 41. UPON REQUEST, THE APPLICANT OR HIS CONTRACTOR SHALL PROVIDE AN AS-BUILT (RECORD DRAWING) FOR ANY SEDIMENT BASIN OR TRAP TO THE MUNICIPAL INSPECTOR, OCAL CONSERVATION DISTRICT OR THE DEPARTMENT.

42. EROSION CONTROL BLANKETING SHALL BE INSTALLED ON ALL SLOPES 3H:1V OR STEEPER WITHIN 50 FEET OF A SURFACE WATER AND ON ALL OTHER DISTURBED AREAS SPECIFIED ON THE PLAN MAPS AND/OR DETAIL SHEETS.

43. FILL MATERIAL FOR EMBANKMENTS SHALL BE FREE OF ROOTS, OR OTHER WOODY VEGETATION, ORGANIC MATERIAL, LARGE STONES, AND OTHER OBJECTIONABLE MATERIALS. 44. NO WETLANDS EXIST WITHIN THE PROJECT BOUNDARY

45. MINE OPENINGS ARE NOT ANTICIPATED. IF MINE SPOILS ARE ENCOUNTERED DURING CONSTRUCTION. THE CONTRACTOR SHALL EITHER REWORK THE MATERIAL PER GEOTECHNICAL ENGINEERS RECOMMENDATIONS OR REMOVE THE MATERIAL TO A PERMITTED AREA.

46. NO SIGNIFICANT CULTURAL OR SENSITIVE ENVIRONEMENTAL FEATURES EXIST WITHIN THE PROJECT BOUNDARY. NO FURTHER ENVIRONMENTAL STUDIES WILL BE 47. NO WATER RESOURCES EXIST WITHIN THE PROJECT BOUNDARY

EROSION AND SEDIMENT CONTROL FACILITIES MAINTENANCE SCHEDULE

1. ALL EROSION AND SEDIMENT CONTROLS SHALL BE MAINTAINED UNTIL A UNIFORM 70% PERENNIAL VEGETATIVE COVER IS ESTABLISHED.

ROCK CONSTRUCTION ENTRANCE

1. THE ROCK CONSTRUCTION ENTRANCES ARE TO BE INSPECTED AT THE END OF EACH WORKING DAY AND REPAIRED IMMEDIATELY. 2. THE THICKNESS OF THE ROCK CONSTRUCTION ENTRANCE SHALL BE CONSTANTLY

3. A ROCK STOCKPILE IS TO BE READILY AVAILABLE ON THE SITE AT ALL TIMES FOR IMMEDIATE REPAIR.

COMPOST FILTER SOCK

1. THE COMPOST FILTER SOCK CONTROLS SHALL BE INSPECTED WEEKLY AND AFTER EACH STORM (RUNOFF) EVENT AND REPAIRED IMMEDIATELY.

ACCUMULATED SEDIMENT SHALL BE REMOVED WHEN DEPOSITS REACH 1/2 THE ABOVE GROUND HEIGHT OF THE SOCK. 3. SILT DEPOSITS SHALL BE TAKEN TO THE TOPSOIL STOCKPILE AREA. THE SILT SHALL

THEN BE SPREAD OVER STOCKPILE, SEEDED AND MULCHED. 4. ALL UNDERCUTTING OR EROSION OF THE COMPOST FILTER SOCK TOE ANCHOR SHALL

BE REPAIRED IMMEDIATELY. 5. ANY COMPOST FILTER SOCK SECTION WHICH HAS BEEN UNDERMINED OR TOPPED SHALL BE IMMEDIATELY REPLACED WITH A ROCK FILTER OUTLET.

1. THE CONTRACTOR SHALL INSPECT VEGETATED AREAS WEEKLY AND AFTER EACH

2. THE CONTRACTOR SHALL INSPECT THE SITE FOR RILLS OR GULLIES ON CUT OR FILL SLOPES. THE CONTRACTOR SHALL FILL RILLS AND GULLIES, REGRADE DISTURBED AREAS TO PROVIDE A UNIFORM SLOPE, THEN RESEED/MULCH AND REPAIR/REPLACE

MATS TO ORIGINAL SPECIFICATIONS. 3. THE REPAIRS SHALL BE MADE WITHIN 2 DAYS OF DISCOVERING PROBLEM.

PUMPED WATER FILTERING DEVICE

RESUME UNTIL THE PROBLEM IS CORRECTED.

THE CONTRACTOR SHALL INSPECT FILTER BAGS DAILY AND AFTER EACH STORM (RUNOFF) EVENT TO ENSURE THEY ARE WORKING PROPERLY. 2. IF ANY PROBLEM IS DETECTED, PUMPING SHALL CEASE IMMEDIATELY AND NOT

3. ALL SEDIMENT REMOVED FROM THE FILTER BAGS SHALL BE TAKEN TO THE TOPSOIL STOCKPILE, SPREAD, SEEDED AND MULCHED.

PERMANENT-STEEP SLOPE

SEEDING DATES: APRIL-SEPT.

SPECIES: BIRDSFOOT TREFOIL AND TALL FESCUE MIX % PURE LIVE SEED: 99% APPLICATION RATE: 10 AND 50 LBS/ACRE. RESPECTIVELY FERTILIZER TYPE: COMMERCIAL FERTILIZER 5-10-10 FERTILIZER APPL. RATE: (PER TESTING) 30 LBS/ACRE LIMING RATE: 1 TONS/ACRE MULCH TYPE: HAY & STRAW MULCHING RATE: 3 TONS/ACRE ANCHORING MATERIAL: NONASPHALTIC MATERIAL ANCHORING METHOD: SPRAY RATE OF ANCHORING MATERIAL APPL.: 1000 GAL/SQ.YD.

1. THE GENERAL CONTRACTOR SHALL NOTIFY ALL UTILITY COMPANIES INVOLVED IN THE SITE NO MORE THAN TEN DAYS AND NO LESS THAN THREE DAYS IN ADVANCE OF EXCAVATION (PA

ACT 287 OF 1974 AMENDED BY ACT 121 OF 2008). TRAFFIC SHALL BE MAINTAINED ON ALL ADJOINING STREETS AND DRIVES AT ALL TIMES.

TRAFFIC CONTROL SHALL BE MAINTAINED IN ACCORDANCE WITH PENNDOT'S REQUIREMENTS. CONTRACTOR SHALL USE ASPHALT WEDGE CURBS, UNLESS NOTED, OUTSIDE OF THE PUBLIC

CONTRACTOR SHALL VERIFY THE LOCATION AND INVERT ELEVATION OF ALL EXISTING UTILITIES

WITH PROPOSED CONNECTIONS PRIOR TO CONSTRUCTION AND GRADING OF THE SITE. THE CONTRACTOR SHALL INSTALL ALL PAVEMENT MARKINGS AS SHOWN ON THE PLANS.

GRADING NOTES:

THE CONTRACTOR SHALL REMOVE ALL EXISTING ASPHALT PAVEMENT AND CONCRETE SLABS

THE CONTRACTOR SHALL PROOF ROLL THE SITE TO THE SATISFACTION OF THE GEOTECHNICAL ENGINEER AND REMOVE ANY SOFT MATERIAL PRIOR TO THE IMPORTING OF ANY FILL MATERIAL.

THE CONTRACTOR SHALL REPLACE ALL CURB SECTIONS, SIDEWALKS, AND PAVEMENT, WHICH HAS BEEN CUT AND DISTURBED WITHIN THE RIGHT-OF-WAY WITH PENNSYLVANIA DEPARTMENT OF TRANSPORTATION'S STANDARD MATERIALS.

THE CONTRACTOR SHALL ADJUST TO GRADE ALL WATER AND GAS VALVES. THE CONTRACTOR SHALL COMPACT ALL FILL MATERIALS OUTSIDE OF PROPOSED BUILDING AREAS, PLACED IN LIFTS, AND COMPACTED TO 90% OF MAXIMUM DRY DENSITY, AS DETERMINED BY ASTM D-1557 (MODIFIED PROCTOR) OR 95% BY ASTM-D698 (STANDARD PROCTOR). PLACE FILL IN EIGHT-INCH LIFTS AND COMPACT WITH AN IMPACT-TYPE ROLLER (I.E. SHEEPSFOOT ROLLER). PROVIDE FOR INSPECTION OF ALL FILL AS IT IS PLACED FOR PROPER DENSITY BY A

GEOTECHNICAL TESTING FIRM. THE CONTRACTOR SHALL COMPACT ALL FILL MATERIALS WITHIN PROPOSED BUILDING AREAS, PLACED IN LIFTS, AND COMPACTED TO 95% OF MAXIMUM DRY DENSITY, AS DETERMINED BY ASTM D-1557 (MODIFIED PROCTOR) OR 100% BY ASTM-D698 (STANDARD PROCTOR). PLACE FILL IN EIGHT-INCH LIFTS AND COMPACT WITH AN IMPACT-TYPE ROLLER (I.E. SHEEPSFOOT ROLLER). PROVIDE FOR INSPECTION OF ALL FILL AS IT IS PLACED FOR PROPER DENSITY BY A GEOTECHNICAL TESTING FIRM.

ALL CUT AND FILL OPERATIONS SHALL FOLLOW THE "PENNSYLVANIA HANDBOOK OF BEST MANAGEMENT PRACTICES FOR DEVELOPING AREAS."

THE CONTRACTOR SHALL USE PENNDOT'S LATEST REFERENCES OF PUBLICATION 408/2000 AND ROADWAY CONSTRUCTION STANDARDS.

SITE STABILIZATION INSTALLATION AND MAINTENANCE (TEMPORARY AND PERMANENT)

1. TILL SOIL TO DEPTH OF 2". REMOVE ALL OBJECTS 2" OR LARGER. 2. BLEND COMMERCIAL FERTILIZER INTO THE SOIL TO A DEPTH OF 2". FERTILIZER

MAY BE BLENDED DURING TILLING. 3. SOW REQUIRED SEED MIXTURE UNIFORMLY ON THE PREPARED AREA BY HYDRAULIC

SEEDING EQUIPMENT, HAND SEEDING. OR ANY OTHER APPROPRIATE METHOD. AFTER SEEDING ROLL TOPSOILED AREAS THAT ARE TO BE MOWED. USE A ROLLER

WEIGHING NOT MORE THAN 65 LBS./FT. WIDTH. FOR PERMANENT SITE STABILIZATION APPLY SLOW RELEASE NITROGEN FERTILIZER TO

THE SURFACE OF SEEDED AREAS. 6. PLACE MULCH IMMEDIATELY AFTER SEEDING OR WITHIN 48 HOURS AFTER SEEDING IS COMPLETED. PLACE HAY & STRAW UNIFORMLY, IN A CONTINUOUS BLANKET AT THE MINIMUM RATE SPECIFIED ABOVE. AN ACCEPTABLE MECHANICAL BLOWER MAY B USED TO APPLY MULCH. MACHINES WHICH CUT MULCH INTO SHORT PIECES WILL

NOT BE PERMITTED. MAINTENANCE - SATISFACTORILY MAINTAIN GRASS AREAS WITHIN GRADING LIMITS, UNTIL THE ENTIRE PROJECT HAS BEEN COMPLETED. MOW, AS INDICATED AND WHEN DIRECTED. CONTROL PROHIBITED AND NOXIOUS WEED GROWTH BY HERBICIDE SPRAYING OR CUTTING. AFTER THE SEEDING AND SOIL SUPPLEMENT WORK ON A SLOPE HAS BEEN SATISFACTORILY COMPLETED, IF A SLOPE FAILURE OCCURS, ONE WHICH REQUIRES REDRESSING, EXCAVATION, OR ESTABLISHMENT OF A NEW

SLOPE, REAPPLY SOIL SUPPLEMENTS, THEN RESEED, AS SPECIFIED FOR THE ORIGINAL TREATMENT. 9. A SITE WILL BE CONSIDERED TO BE PERMANENTLY STABILIZED WHEN ALL PERMANENT CONTROL MEASURES AND FACILITIES HAVE BEEN COMPLETED AND ARE OPERATIONAL, TEMPORARY CONTROL MEASURES AND FACILITIES REMOVED, AND UNIFORM 70% PERENNIAL VEGETATION COVER IS ESTABLISHED TO THE POINT WHERE THE SURFACE SOIL IS CAPABLE OF RESISTING EROSION DURING RUNOFF EVENTS. THE STANDARD FOR THIS VEGETATIVE COVER WILL BE A UNIFORM COVERAGE OR

DENSITY OF 70% ACROSS THE DISTURBED AREA. 10. THE CONTRACTOR SHALL MAINTAIN THE SITE PER THE PROVISIONS OF THIS PLAN UNTIL PERMANENT STABILIZATION IS ESTABLISHED.

TEMPORARY STABILIZATION

SPECIES: ANNUAL RYEGRASS % PURE LIVE SEED: 98% APPLICATION RATE: 50 LBS/ACRE FERTILIZER TYPE: COMMERCIAL FERTILIZER 10-20-20 FERTILIZER APPL. RATE: 678 LBS/ACRE LIMING RATE: 2 TONS/ACRE MULCH TYPE: HAY & STRAW

PERMANENT STABILIZATION

MULCHING RATE: 3 TONS/ACRE

 POA PRATENSIS (KENTUCKY BLUEGRASS) 90% PURE LIVE SEED, APPLICATION RATE 50LBS/AC

• FESTUCA RUBRA VAR. 'PENNLAWN" (PENNLAWN RED FESCUE) 98% PURE LIVE SEED, APPLICATION RATE 30LBS/AC

 LOLIUM PERENNE (PERENNIAL RYEGRASS) 98% PURE LIVE SEED, APPLICATION RATE 20LBS/AC FERTILIZER: COMMERCIAL FERTILIZER, 10-20-20, 1,000 LBS./ACRE LIMING: 4,000 LBS./ACRE

MULCH: WHEAT OR OAT STRAW WELL CURED TO LESS THAN 20% MOISTURE BY WEIGHT, 5,800 POUNDS PER ACRE SPRING - MARCH TO MAY 30. SEEDING DATES: FALL - SEPTEMBER 1 TO OCTOBER 15

THE ENGINEER ASSUMES NO RESPONSIBILITY FOR ANY CHANGES IN DESIGN PLANS UNLESS WRITTEN

CONSENT IS GIVEN BY THE ENGINEER. THE CONTRACTOR AND/OR THE OWNER WILL BE HELD RESPONSIBLE FOR ANY FIELD MODIFICATIONS MADE WITHOUT THE WRITTEN CONSENT OF THE ENGINEER AND NECESSARY APPROVALS BY PERMITTING AGENCIES. THE LOCATION OF EXISTING UTILITIES WERE TAKEN FROM RECORDS AND MARKING PROVIDED BY OTHERS AND OBSERVED EVIDENCE. THE LOCATIONS SHOWN MAY BE APPROXIMATE. THE CONTRACTOR IS RESPONSIBLE FOR DETERMINING THE EXACT LOCATIONS, SIZES AND DEPTH OF ALL UTILITIES PRIOR TO CONSTRUCTION. THE CONTRACTOR SHALL EXERCISE CARE TO AVOID DAMAGE TO ALL EXERCISE C

© 2021 MORRIS KNOWLES & ASSOCIATES, INC. (A HAMMONTREE COMPANY) — THESE DRAWINGS SHALL NOT BE USED BY ANY PERSON, FIRM OR CORPORATION WITHOUT SPECIFIC WRITTEN PERMISSION FROM MORRIS KNOWLES & ASSOCIATES, INC. THESE PLANS ARE NOT TO BE REPRODUCED, CHANGED OR MANIPULATED IN ANY FORM OR MANNER WHATSOEVER, NOR ARE THEY TO BE ASSIGNED TO ANY THIRD PARTY WITHOUT PERMISSION AND CONSENT OF MORRIS KNOWLES & ASSOCIATES INC.



SHEET NO. C700

APPROXIMATE LOCATIONS, IT IS THE RESPONSIBILITY OF THE CONTRACTOR TO GAIN EXACT LOCATIONS AND DEPTH OF ALL UTILITIES PRIOR TO ANY CONSTRUCTION.

NOTES:
THE ENGINEER ASSUMES NO RESPONSIBILITY FOR ANY

CHANGES IN DESIGN PLANS UNLESS WRITTEN CONSENT

IS GIVEN BY ENGINEER. CONTRACTOR AND/OR OWNER

MODIFICATIONS MADE WITHOUT WRITTEN CONSENT OF

ENGINEER. ALL UTILITIES SHOWN ON PLANS ARE IN

WILL BE HELD RESPONSIBLE FOR ANY FIELD


444444

SCALE:

S

≒જ્ર≎

0

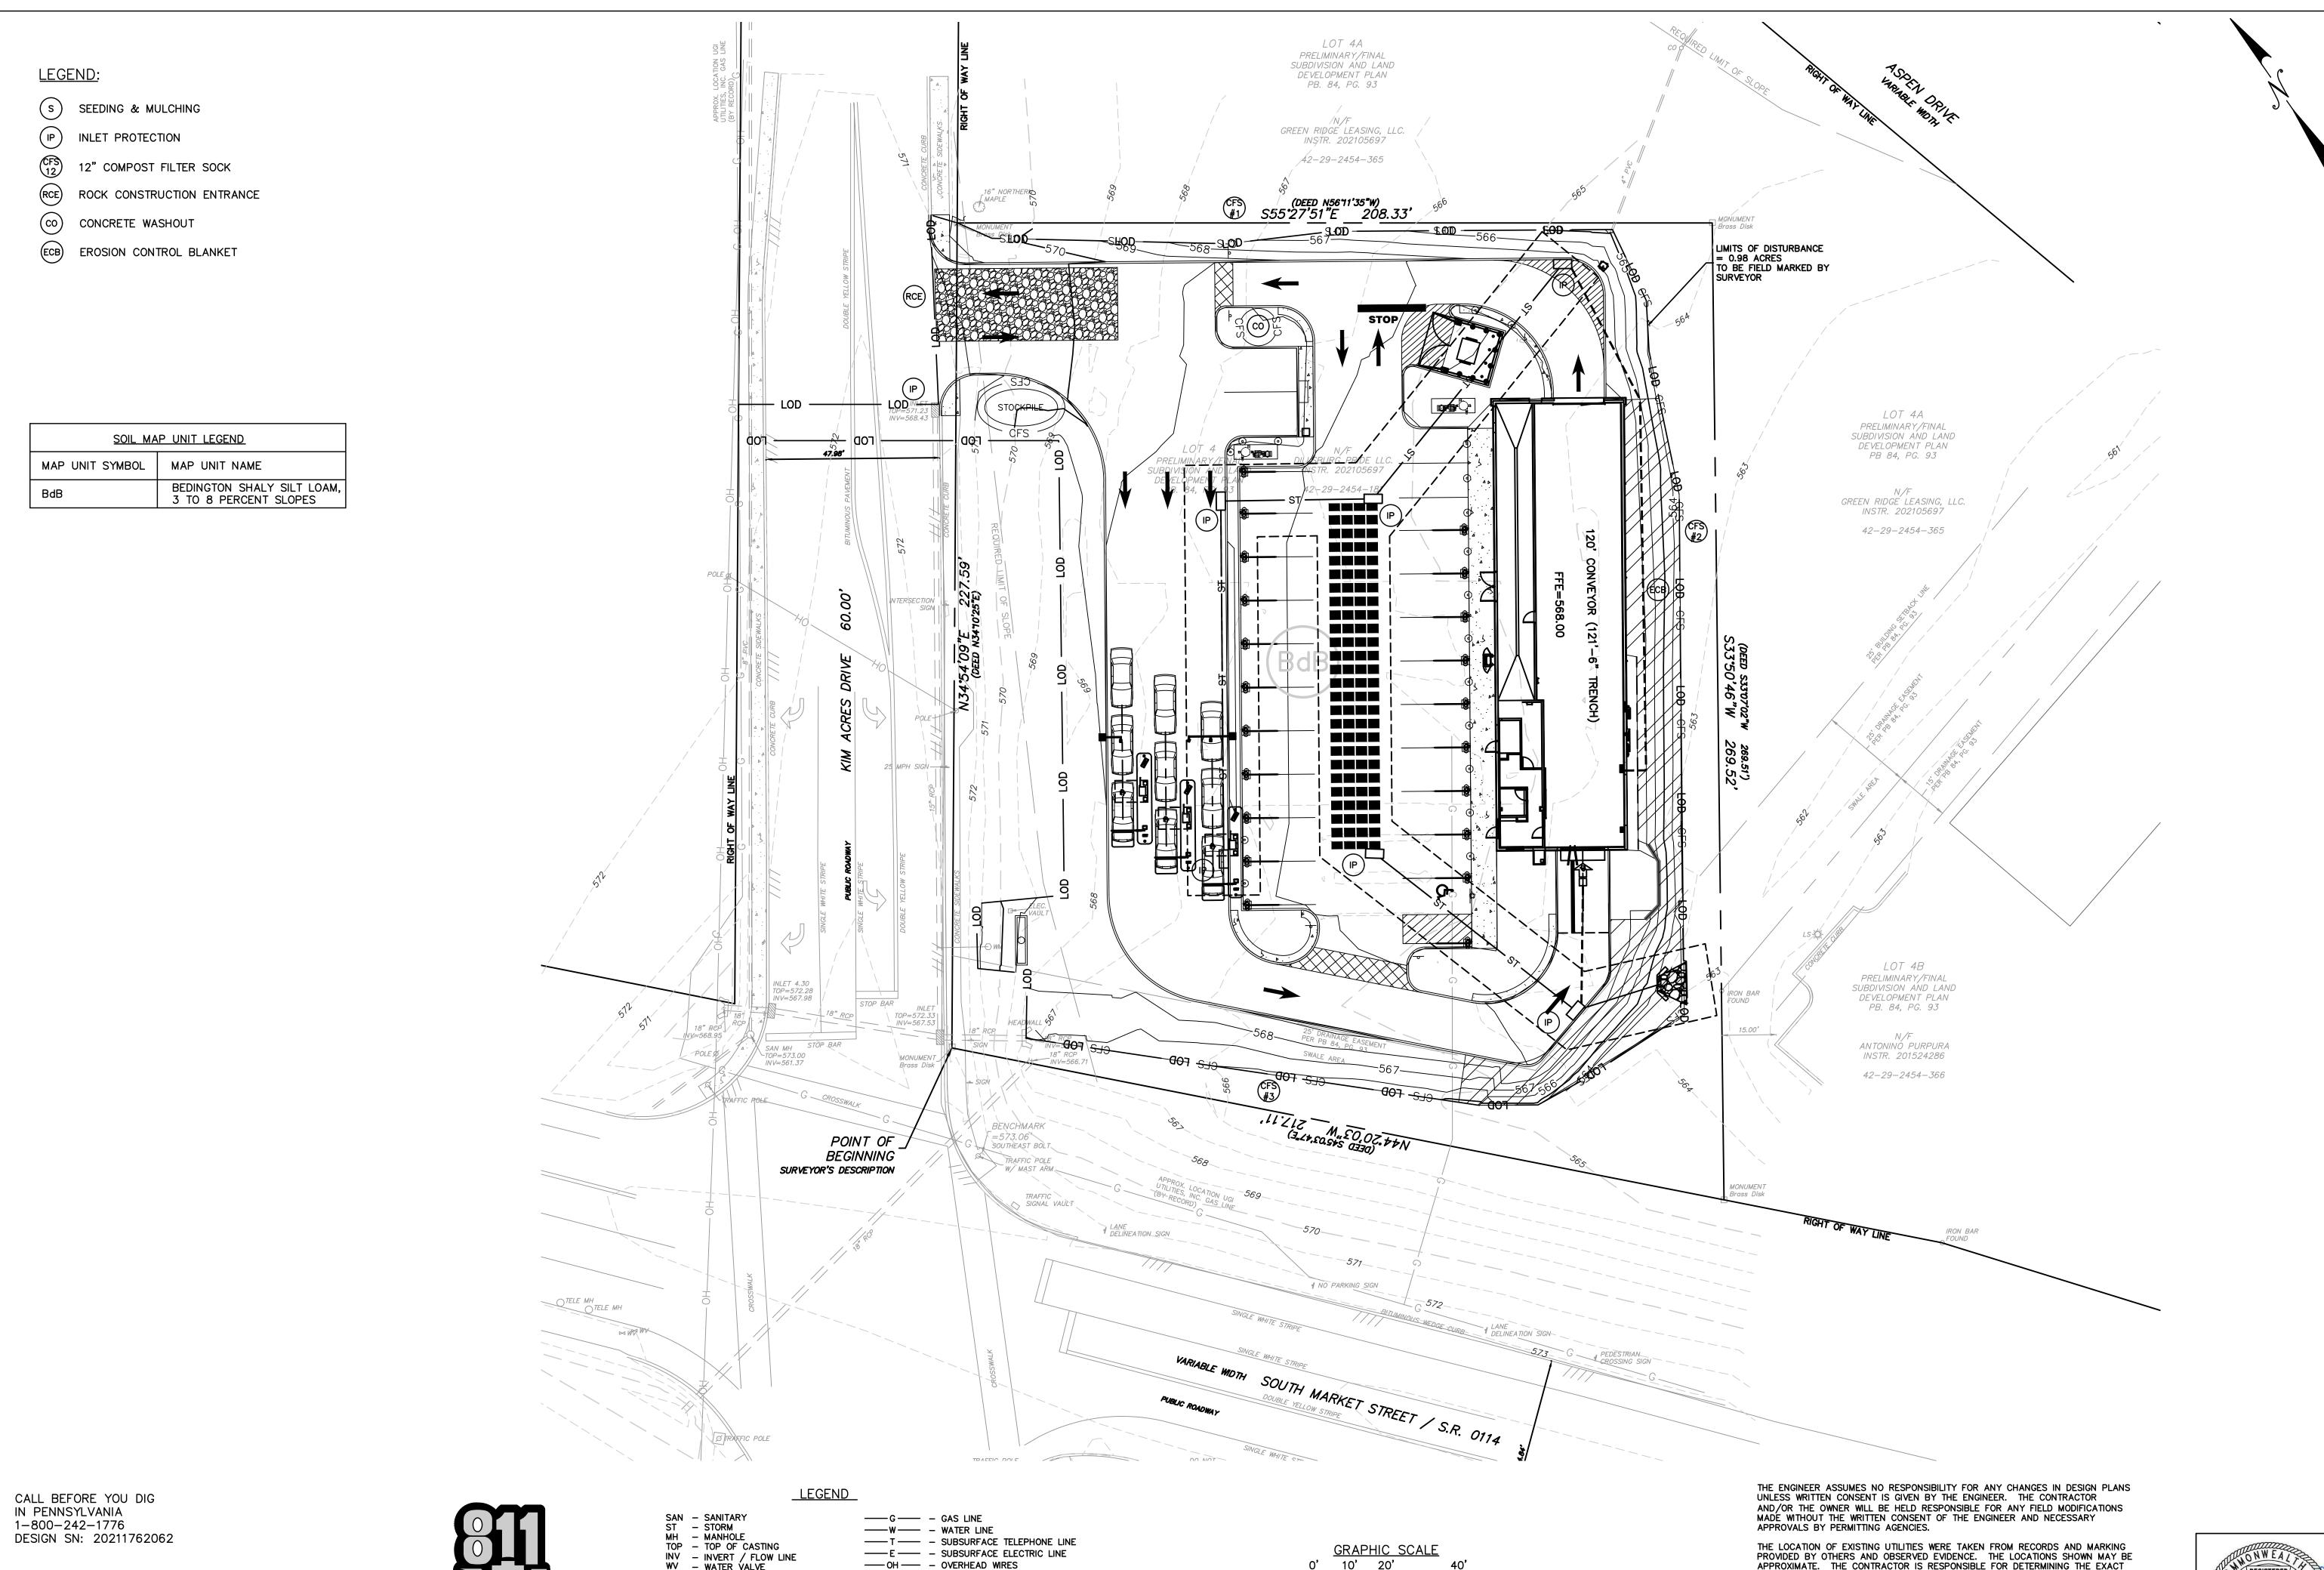


THE GENERAL CONTRACTOR SHALL NOTIFY ALL UTILITY COMPANIES INVOLVED IN THE SITE NO MORE TEN DAYS AND NO LESS THAN THREE DAYS IN ADVANCE OF EXCAVATION Know what's below (PA ACT 287 OF 1974 AMENDED BY ACT 50 OF 2018). PA STATE LAW REQUIRES 3 WORKING DAYS NOTICE


Call before you dig




RCP - REINFORCED CONCRETE PIPE

CPP - CORRUGATED PLASTIC PIPE

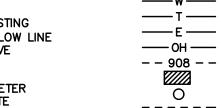


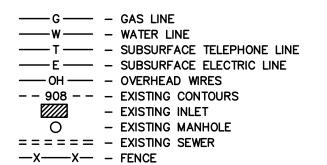

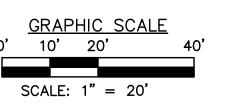

THE LOCATION OF EXISTING UTILITIES WERE TAKEN FROM RECORDS AND MARKING PROVIDED BY OTHERS AND OBSERVED EVIDENCE. THE LOCATIONS SHOWN MAY BE APPROXIMATE. THE CONTRACTOR IS RESPONSIBLE FOR DETERMINING THE EXACT LOCATIONS, SIZES AND DEPTH OF ALL UTILITIES PRIOR TO CONSTRUCTION. THE CONTRACTOR SHALL EXERCISE CARE TO AVOID DAMAGE TO ALL EXISTING UTILITIES.

© 2018 MORRIS KNOWLES & ASSOCIATES, INC. (A HAMMONTREE COMPANY) -THESE DRAWINGS SHALL NOT BE USED BY ANY PERSON, FIRM OR CORPORATION WITHOUT SPECIFIC WRITTEN PERMISSION FROM MORRIS KNOWLES & ASSOCIATES, INC. THESE PLANS ARE NOT TO BE REPRODUCED, CHANGED OR MANIPULATED IN ANY FORM OR MANNER WHATSOEVER, NOR ARE THEY TO BE ASSIGNED TO ANY THIRD PARTY WITHOUT PERMISSION AND CONSENT OF MORRIS KNOWLES & ASSOCIATES, INC.

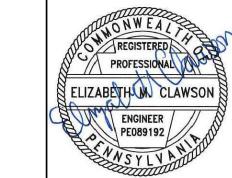

C701

SHEET NO.

ЕЕЕЕЕЕ

DES DR, DA

1"=20'

SCALE:

Orris & Ass (A Ham

2"X2" WOODEN STAKES FILTER SOCK UNDISTURBED PLACED 10' O.C. **PLAN VIEW**

NOTES:

MATERIAL TYPE

Sock fabric shall meet standards of Table 4.1. Compost shall meet the standards of Table 4.2. Compost filter sock shall be placed at existing level grade. Both ends of the sock shall be extended at least 8 feet up slope at 45 degrees to the main sock alignment (Figure 4.1). Maximum slope length above any sock shall not exceed that shown on Figure 4.2. Stakes may be installed immediately downslope of the sock if so specified by the manufacturer.

Traffic shall not be permitted to cross filter socks.


mulch spread as a soil supplement.

Accumulated sediment shall be removed when it reaches half the aboveground height of the sock and disposed in the manner described elsewhere in the plan.

Socks shall be inspected weekly and after each runoff event. Damaged socks shall be repaired according to manufacturer's specifications or replaced within 24 hours of inspection.

Biodegradable filter socks shall be replaced after 6 months: photodegradable socks after 1 year. Polypropylene socks shall be replaced according to manufacturer's recommendations. Upon stabilization of the area tributary to the sock, stakes shall be removed. The sock may be left in place and vegetated or removed. In the latter case, the mesh shall be cut open and the

> STANDARD CONSTRUCTION DETAIL #4-1 COMPOST FILTER SOCK

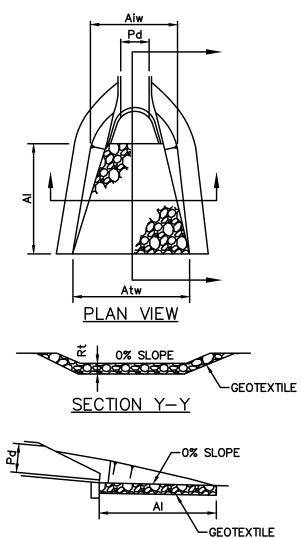

SECTION Z-Z

HE BLANKET SHOULD OVERLAP BLANKET ENDS 6" (MIN.) NOT BE STRETCHED; WITH THE UPSLOPE BLANKET OVERLYING THE DOWNSLOPE BLANKET IT MUST MAINTAIN GOOD SOIL CONTACT (SHINGLE STYLE), STAPLE SECURELY

STARTING AT TOP OF SLOPE,

DIRECTION OF WATER FLOW

ROLL BLANKETS IN

BLANKET EDGES

AND STAPLED

OVERLAPPED 4" (MIN.)

CONTRICTO STATES

Seed and soil amendments shall be applied according to the rates in the plan drawings prior to installing the blanket.

INSTALL BEGINNING OF ROLL

PREPARE SEED BED

OF BLANKET

REFER TO MANUFACTURER'S

RECOMMENDED STAPLING PATTERN

FOR STEEPNESS AND LENGTH OF SLOPE BEING BLANKETED

(INCLUDING APPLICATION OF

LIME, FERTILIZER, & SEED)

PRIOR TO INSTALLATION

IN 6"x6" ANCHOR TRENCH,

STAPLE, BACKFILL AND

Provide anchor trench at toe of slope in similar fashion as at top of slope.

Slope surface shall be free of rocks, clods, sticks, and grass.

Blanket shall have good continuous contact with underlying soil throughout entire length. Lay blanket loosely and stake or staple to maintain direct contact with soil. Do not stretch blanket.

The blanket shall be stapled in accordance with the manufacturer's recommendations. Blanketed areas shall be inspected weekly and after each runoff event until perennial vegetation is established to a minimum uniform 70% coverage throughout the blanketed area. Damaged or displaced blankets shall be restored or replaced within 4 calendar days.

STANDARD CONSTRUCTION DETAIL #11-1 **EROSION CONTROL BLANKET INSTALLATION**

5 MIL HDPE	5 MIL HDPE	MULTI-FILAMENT POLYPROPYLENE (MFPP)	HEAVY DUTY MULTI-FILAMENT POLYPROPYLENE (HDMFPP)
PHOTO-	BIO-	PHOTO-	PHOTO-

				(MFPP)	POLYPROPYLENE (HDMFPP)
MATERIAL CHARACTERISTICS	PHOTO— DEGRADABLE	PHOTO- DEGRADABLE	BIO- DEGRADABLE	PHOTO- DEGRADABLE	PHOTO- DEGRADABLE
SOCK DIAMETERS	12" 18"	12" 18" 24" 32"	12" 18" 24" 32"	12" 18" 24" 32"	12" 18" 24" 32"
MESH OPENING	3"	3" 8	3" 8	3" 8	1" 8
TENSILE STRENGTH		26 PSI	26 PSI	44 PSI	202 PSI
ULTRAVIOLET STABILITY % ORIGINAL STRENGTH (ASTM G-155)	23% AT 1000 HR	23% AT 1000 HR		100% AT 1000 HR	100% AT 1000 HR
MINIMAL FUNCTIONAL LONGEVITY	6 MONTHS	9 MONTHS	6 MONTHS	1 YEAR	2 YEARS
ININED CONTAININENT NE	TTIMO	TWO-PLY	SYSTEMS	LIDDE DIAMAL NET	•
INNER CONTAINMENT NE	LITING			HDPE BIAXIAL NET CONTINUOUSLY WOUND)
		<u> </u>		TUCION WELDED HING	

TABLE 4.1


COMPOST SOCK FABRIC MINIMUM SPECIFICATIONS

USION-WELDED JUNCTURES "X ¾" MAX. APERTURE SIZE OUTER FILTRATION MESH COOMPOSITE POLYPROPYLENE FABRIC (WOVEN LAYER AND NON-WOVEN FLEECE MECHANICALLY FUSED VIA NEEDLE PUNCH) 용" MAX. APERTURE SIZE SOCK FABRICS COMPOSED OF BURLAP MAY BE USED ON PROJECTS LASTING 6 MONTHS OR LESS.


FILTREXX & JMD

COMPOST STANDARDS

ORGANIC MATTER CONTENT	25% - 100% (DRY WEIGHT BASIS)
ORGANIC PORTION	FIBROUS AND ELONGATED
pH	5.5 - 8.5
MOISTURE CONTENT	30% - 60%
PARTICLE SIZE	30% - 50% PASS THROUGH ₹ SIEVE
SOLUBLE SALT CONCENTRATION	5.0 dS/m (MMHOS/CM) MAXIMUM

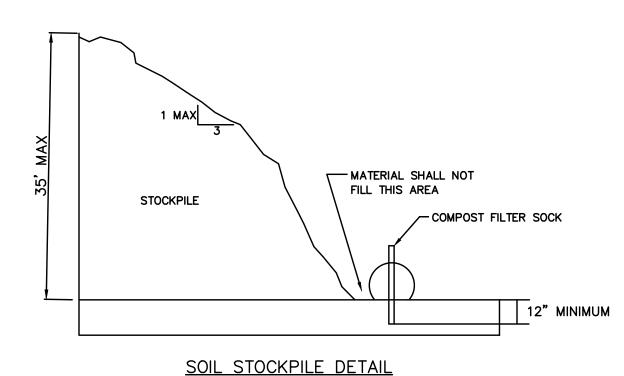


N.T.S.

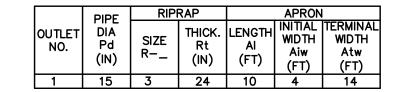

ALL APRONS SHALL BE CONSTRUCTED TO THE DIMENSIONS SHOWN. TERMINAL WIDTHS SHALL BE ADJUSTED AS NECESSARY TO MATCH RECEIVING CHANNELS. ALL APRONS SHALL BE INSPECTED AT LEAST WEEKLY AND AFTER EACH RUNOFF EVENT. DISPLACED RIPRAP WITHIN THE APRON SHALL BE REPLACED IMMEDIATELY.

> STANDARD CONSTRUCTION DETAIL #9-1 RIPRAP APRON AT PIPE OUTLET WITH FLARED END SECTION OR ENDWALL N.T.S.

FIGURE 3.18 TYPICAL COMPOST SOCK WASHOUT INSTALLATION

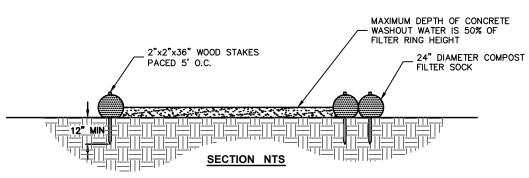

NOTES:

1. INSTALL ON FLAT GRADE FOR OPTIMUM PERFORMANCE 2. 18" DIAMETER FILTER SOCK MAY BE STACKED ONTO DOUBLE 24" DIAMETER SOCKS IN PYRAMIDAL CONFIGURATION FOR ADDED HEIGHT 2"x2"x36" WOOD STAKES WASHOUT WATER INTO SIDE OF FILTER RIN

A SUITABLE IMPERIOUS GEOMEMBRANE SHALL BE PLACED AT THE LOCATION OF THE WASHOUT PRIOR TO INSTALLING THE SOCKS. ADAPTED FROM FILTREXX

A. LIMIT ADVANCE CLEARING AND GRUBBING OPERATIONS TO A DISTANCE EQUAL TO TWO TIMES THE LENGTH OF PIPE INSTALLATION THAT CAN BE COMPLETED IN ONE DAY.


B. WORK CREWS AND EQUIPMENT FOR TRENCHING, PLACEMENT OF PIPE, PLUG CONSTRUCTION AND BACKFILLING WILL BE SELF CONTAINED AND SEPARATE FROM CLEARING AND GRUBBING AND SITE RESTORATION AND STABILIZATION OPERATIONS.

C. LIMIT DAILY TRENCH EXCAVATION TO THE LENGTH OF PIPE PLACEMENT, PLUG INSTALLATION AND BACKFILLING THAT CAN BE COMPLETED THE SAME DAY.

D. TREN	D.TRENCH PLUGS WILL BE SPACED IN ACCORDANCE WITH THE TABLE BELOW:						
	TRENCH SLOPE %	LENGTH (FEET)	PLUG MATERIAL				
	0 - 5		NONE				
	5 - 15	500	EARTH FILLED SACKS				
	15 – 25	300	EARTH FILLED SACKS				
	25 - 35	200	EARTH FILLED SACKS				
	35 - 100	100	EARTH FILLED SACKS				
	OVER 100	50	CEMENT FILLED BAGS (WETTED)				

/ILL REMAIN IN EFFECT WITH THE FOLLOWING EXCEPTIONS:
. DAILY BACKFILLING OF THE TRENCH MAY BE DELAYED FOR SIX DAYS.
. IF DAILY BACKFILLING IS DELAYED. THE DISTURBED AREA WILL BE GRADED TO FINAL CONTOURS FOR UTILITIES THAT REQUIRE TESTING BEFORE THE TRENCH IS BACKFILLED, ALL OF THE ABOVE ITEMS APPROPRIATE TEMPORARY EROSION AND SEDIMENT CONTROL MEASURES/FACILITIES WILL BE INSTALLED AND THE AREAS SEEDED AND MULCHED WITHIN THE NEXT TWO DAYS.

UTILITY TRENCH EXCAVATING GUIDELINES

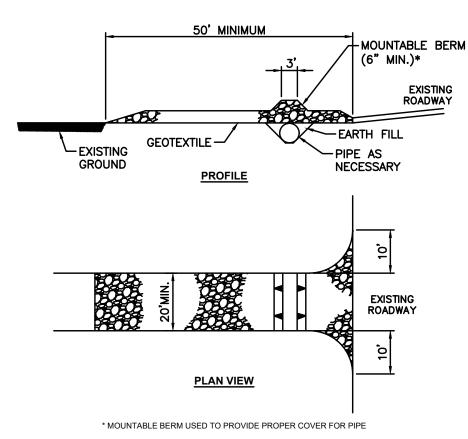

NOTES:


Remove topsoil prior to installation of rock construction entrance. Extend rock over full width of entrance.

Runoff shall be diverted from roadway to a suitable sediment removal bmp prior to entering rock construction entrance.

Mountable berm shall be installed wherever optional culvert pipe is used and proper pip cover as specified manufacturer is not otherwise provided. Pipe shall be sized appropriately for size of ditch being crossed.

MAINTENANCE: Rock Construction Entrance thickness shall be constantly maintained to the specified dimensions by adding rock. A stockpile shall be maintained on site for this purpose. At the end of each construction day, all sediment deposited on paved roadways shall be removed and returned to the construction site immediately. If excessive amounts of sediment are being deposited on roadway, extent length of rock construction entrance by 50 foot increments until condition is alleviated or install wash rack. Washing the roadway or sweeping the deposits into roadway ditches, sewers, culverts, or other drainage courses is

> STANDARD CONSTRUCTION DETAIL #3-1 ROCK CONSTRUCTION ENTRANCE N.T.S.

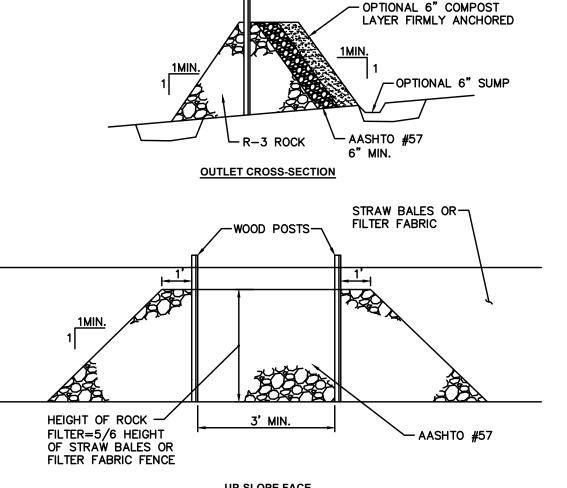


UP-SLOPE FACE

NOTES:

A rock filter outlet shall be installed where failure of a silt fence or straw bale barrier has occurred due to concentrated flow. Anchored compost layer shall be used on upslope face in HQ and EV watersheds.

Sediment shall be removed when accumulations reach 1/3 the height of the outlet.

STANDARD CONSTRUCTION DETAIL #4-6 **ROCK FILTER OUTLET**

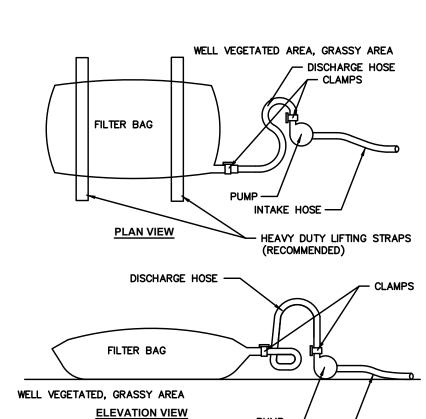

Low volume filter bags shall be made from non-woven geotextile material sewn with high strength, double stitched "J" type seams. They shall be capable trapping particles larger than 150 microns. High volume filter

INTAKE HOS

bags shall be made from woven geotextiles that meet the following standards:								
	Property	Test Method	Minimum Standard					
	Avg. wide width strenght	ASTM D-4884	60 lb/in					
	Grab tensile	ASTM D-4632	250 lb					
	Puncture	ASTM D-4833	110 lb					
	Mullen burst	ASTM D-3786	350 psi					
	UV resistance	ASTM D-4355	70%					
	AOS % retained	ASTM D-4751	80 sieve					

A suitable means of accessing the bag with machinery required for disposal purposes shall be provided. Filter bags shall be replaced when they become 1/2 full of sediment. Spare bags shall be kept available for replacement of those that have failed or are filled. Bags shall be placed on straps to facilitate removal unless bags come with lifting straps already attached.

Bags shall be located in well-vegetated (grassy) area, and discharge onto stable, erosion resistant areas. Where this is not possible, a geotextile underlayment and flow path shall be provided. Bags may be placed on filter stone to increase discharge capacity. Bags shall not be placed on slopes greater than 5%. For slopes exceeding 5%, clean rock or other non-erodible and non-polluting material may be placed under the bag to reduce slope steepness.


No downslope sediment barrier is required for most installations. Compost berm or compost filter sock shall be installed below bags located in HQ or EV watersheds, within 50 feet of any receiving surface water or where grassy area is not available.

The pump discharge hose shall be inserted into the bags in the manner specified by the manufacturer and securely clamped. A piece of PVC pipe is recommended for this purpose.

The pumping rate shall be no greater than 750 gpm or 1/2 the maximum specified by the manufacturer, whichever is less. Pump intakes shall be floating and screened.

Filter bags shall be inspected daily. If any problem is detected, pumping shall cease immediately and not resume until the problem is corrected.

STANDARD CONSTRUCTION DETAIL #3-16 PUMPED WATER FILTER BAG N.T.S.

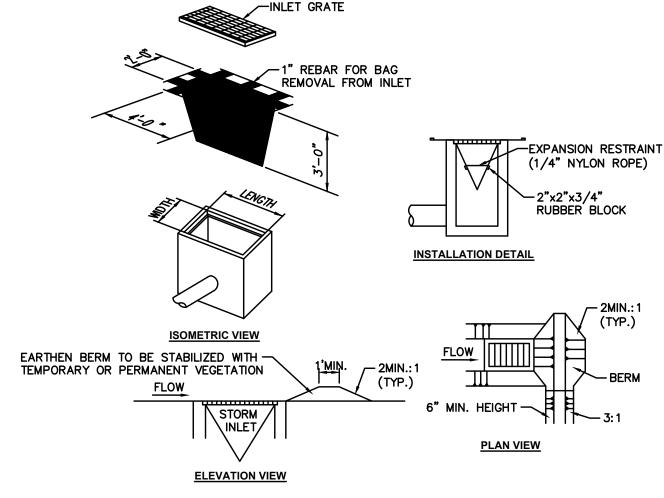

NOTES:

Maximum drainage area = 1/2 acre.

Inlet protection shall not be required for inlet tributary to sediment basin or trap. Berms shall be required for all installations

Rolled earthen berm shall be maintained until roadway is stoned. Road subbase berm shall be maintained until roadway is paved. Earthen berm in channel shall be maintained until permanent stabilization is completed or remain permanently.

At a minimum, the fabric shall have a minimum grab tensile strength of 120 lbs, a minimum burst strength of 200 psi, and a minimum trapezoidal tear strength of 50 lbs. Filter bags shall be capable of trapping all particles not passing a No. 40 Sieve.

Inlet filter bags shall be inspected on a weekly basis and after each runoff event. Bags shall be emptied and rinsed or replaced when half full or when flow capacity has been reduced so as to cause flooding or bypassing of the inlet. Damaged or clogged bags shall be replaced. A supply shall be maintained on site for replacement of bags. All needed repairs shall be initiated immediately after the inspection. Dispose of accumulated sediment as well as all used bags according to the plan notes.


DO NOT USE ON MAJOR PAVED ROADWAYS WHERE PONDING MAY CAUSE TRAFFIC

STANDARD CONSTRUCTION DETAIL #4-16 FILTER BAG INLET PROTECTION - TYPE M INLET

THE ENGINEER ASSUMES NO RESPONSIBILITY FOR ANY CHANGES IN DESIGN PLANS UNLESS WRITTEN CONSENT IS GIVEN BY THE ENGINEER. THE CONTRACTOR AND/OR THE OWNER WILL BE HELD RESPONSIBLE FOR ANY FIELD MODIFICATIONS MADE WITHOUT THE WRITTEN CONSENT OF THE ENGINEER AND NECESSARY APPROVALS BY PERMITTING AGENCIES.

THE LOCATION OF EXISTING UTILITIES WERE TAKEN FROM RECORDS AND MARKING PROVIDED BY OTHERS AND OBSERVED EVIDENCE. THE LOCATIONS SHOWN MAY BE APPROXIMATE. THE CONTRACTOR IS RESPONSIBLE FOR DETERMINING THE EXACT LOCATIONS, SIZES AND DEPTH OF ALL UTILITIES PRIOR TO CONSTRUCTION. THE CONTRACTOR SHALL EXERCISE CARE TO AVOID DAMAGE TO ALL EXISTING UTILITIES.

© 2021 MORRIS KNOWLES & ASSOCIATES, INC. (A HAMMONTREE COMPANY) -THESE DRAWINGS SHALL NOT BE USED BY ANY PERSON, FIRM OR CORPORATION WITHOUT SPECIFIC WRITTEN PERMISSION FROM MORRIS KNOWLES & ASSOCIATES, INC. THESE PLANS ARE NOT TO BE REPRODUCED, CHANGED OR MANIPULATED IN ANY FORM OR MANNER WHATSOEVER, NOR ARE THEY TO BE ASSIGNED TO ANY THIRD PARTY WITHOUT PERMISSION AND CONSENT OF MORRIS KNOWLES & ASSOCIATES, INC.

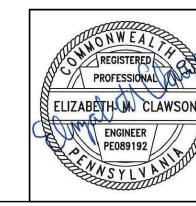

ELIZABETHUM CLAWSON


SHEET NO. C702

R R R R R R R

SCALE:

S

``\& <

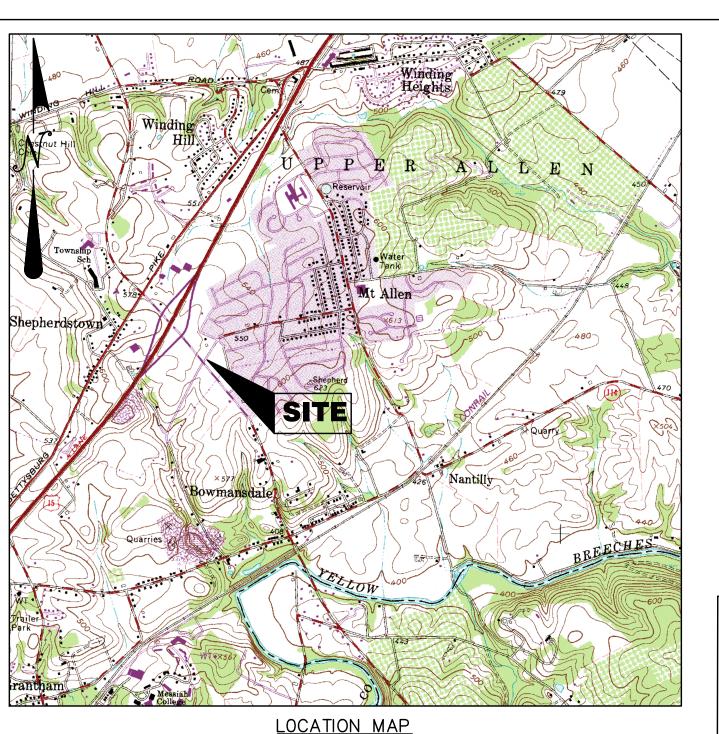

LOCATION MAP

SCALE: 1"=2000'
USGS QUADRANGLE MAP
LEMOYNE, PA

NOTES:

- . THE OWNER OF THE PROPERTY IS THERBY THE OWNER OF ALL PERMANENT STORMWATER FACILITIES AND SHALL BE RESPONSIBLE FOR THE MAINTENANCE AND OPERATION OF ALL SUCH FACILITIES.
- 2. THE RECEIVING WATER COURSE IS UNNAMED TRIBUTARY TO YELLOW BREECHES CREEK WHICH IS DESIGNATED AS A COLD WATER FISHERY (CWF) BY THE PENNSYLVANIA DEPARTMENT OF ENVIRONMENTAL PROTECTION, CHAPTER 93.

 3. ALL BUILDING MATERIALS AND CONSTRUCTION WASTES SUCH AS EXCESS OR UNSUITABLE SOIL, ASPHALT MILLINGS, CONCRETE, ETC. SHALL BE REMOVED FORM THE SITE AND RECYCLED OR DISPOSED OF IN ACCORDANCE WITH THE DEPARTMENT'S SOLID WASTE MANAGEMENT REGULATIONS AT 25 PA. CODE 260.1 ET. SEQ., 271.1, AND 287.1 ET. SEQ. NO BUILDING MATERIALS OR WASTES OR UNUSED BUILDING MATERIALS SHALL BE BURNED, BURIED, DUMPED, OR DISCHARGED AT THE SITE.
- ALL OFF-SITE WASTE AND BORROW AREAS MUST HAVE AN E&S PLAN APPROVED BY THE LOCAL CONSERVATION DISTRICT OR THE DEPARTMENT FULLY IMPLEMENTED PRIOR TO BEING ACTIVATED.
- 5. A LOG SHOWING DATES THAT E&S BMPS WERE INSPECTED AS WELL AS ANY DEFICIENCIES FOUND AND THE DATE THEY WERE CORRECTED SHALL BE MAINTAINED ON THE SITE AND BE MADE AVAILABLE TO REGULATORY AGENCY OFFICIALS AT THE TIME OF INSPECTION. INSPECTIONS SHALL BE LOGGED ON THE MOST CURRENT DEP FORM 3150—FM—BWEW0083 AND KEPT ON SITE AT ALL TIMES.
- 6. CLEAN SEDIMENT COLLECTED FROM BMPs SHALL BE SPREAD OUT IN AN AREA UPSLOPE FROM E&S BMPs IN ORDER TO BE DRIED OUT AND THEN REUSED OR STOCKPILED. ALL MATERIAL REMOVED FROM THE SITE SHALL BE DISPOSED OF PROPERLY IN AN APPROVED C&D LANDFILL. IF CLEAN FILL MATERIAL IS REMOVED FROM THE SITE, IT SHALL BE TAKEN TO AN APPROVED C&D LANDFILL OR IT IS THE CONTRACTOR'S RESPONSIBILITY TO OBTAIN AN APPROVED E&S PLAN FOR THE OTHER SITE.
- 7. THERE ARE NO ANTICIPATED OR KNOWN GEOLOGIC FORMATIONS THAT COULD CAUSE POLLUTION. HOWEVER, COMPOST FILTER SOCK AND UTILITY TRENCHING GUIDELINE WILL BE FOLLOWED TO MINIMIZE ANY IMPACTS.
- 8. THERMAL IMPACTS: APPROPRIATELY SPACED INLETS WILL MINIMIZE PAVEMENT OVERLAND FLOW AND MINIMIZE THERMAL IMPACTS TO DISCHARGING STORMWATER RUNOFF. AREAS THAT ARE NOT PAVED WILL BE LAWN COVERED. STORMWATER RUNOFF WILL DISCHARGE INTO AN UNDERGROUND DETENTION FACILITY TO COOL THE WATER PRIOR TO LEAVING THE

STORMWATER MANAGEMENT CONSTRUCTION SEQUENCE:

STAGE 1: INSTALLATION OF UNDERGROUND DETENTION FACILITY

A. WHEN SITE IS STABILIZED WITH UNIFORM 70% PERENNIAL VEGETATIVE COVER OVER PROJECT AREA, INSTALL STORMWATER MANAGEMENT FACILITY.

STAGE 2: INSTALL UNDERGROUND DETENTION FACILITY PER DETAIL AND SPECIFICATION. CONTRACTOR SHALL PREVENT COMPACTION WITHIN INFILTRATION AREA TO THE GREATEST EXTEND POSSIBLE. IN THE EVENT OF COMPACTION, WITHIN THE INFILTRATION ZONE, THE CONTRACTOR SHALL SCARIFY THE SOIL TO PROMOTE INFILTRATION.

- A. INSTALL NON-WOVEN GEOTEXTILE ALONG BOTTOM OF INFILTRATION AREA.
 B. INSTALL OUTLET STRUCTURE AND WEIR PLATES ACCORDING TO THE PLAN SHEET
- CBUT.

 C. INSTALL AND CONNECT PERFORATED HDPE PIPES TO OUTLET STRUCTURE. BACKFILL WITH 2B STONE PER SPECIFICATIONS ON C801.
- D. CONNECT STORM SEWER PIPING TO THE UNDERGROUND DETENTION FACILITY.

 E. **THE CRITICAL STAGE IN WHICH LICENSED PROFESSIONAL OR DESIGNEE MUST BE
- E. **THE CRITICAL STAGE IN WHICH LICENSED PROFESSIONAL OR DESIGNEE MUST ON—SITE IS PRIOR TO THE STONE BEDDING BEING LAID, INSTALLATION OF PERFORATED HDPE PIPES AND OUTLET STRUCTURE, AND BACKFILLING OF PERFORATED HDPE PIPES.**

LANDSCAPE RESTORATION SEQUENCE:

- A. PERMANENT SEEDING SHALL BE ERNST SEED MIX ERNMX-181 NATIVE STEEP SLOPE
- MIX OR EQUIVALENT.

 B. DISTURBED AREA TO BE RE-PLANTED WITH VEGETATION AS SHOWN ON PLAN.

LEGEND

 SAN - SANITARY
 — G —

 ST - STORM
 — W —

 MH - MANHOLE
 — T —

 TOP - TOP OF CASTING
 — E —

 INV - INVERT / FLOW LINE
 — E —

 WV - WATER VALVE
 — OH —

 GV - GAS VALVE
 — - 908

 GM - GAS METER
 —

 EM - ELECTRIC METER
 O

 S.R. - STATE ROUTE
 — = = = =

 TELE - TELEPHONE
 = = = = =


 RCP - REINFORCED CONCRETE PIPE
 — X — X

CPP - CORRUGATED PLASTIC PIPE



CALL BEFORE YOU DIG IN PENNSYLVANIA 1–800–242–1776 DESIGN SN: 20211762062

Know what's below Call before you dig

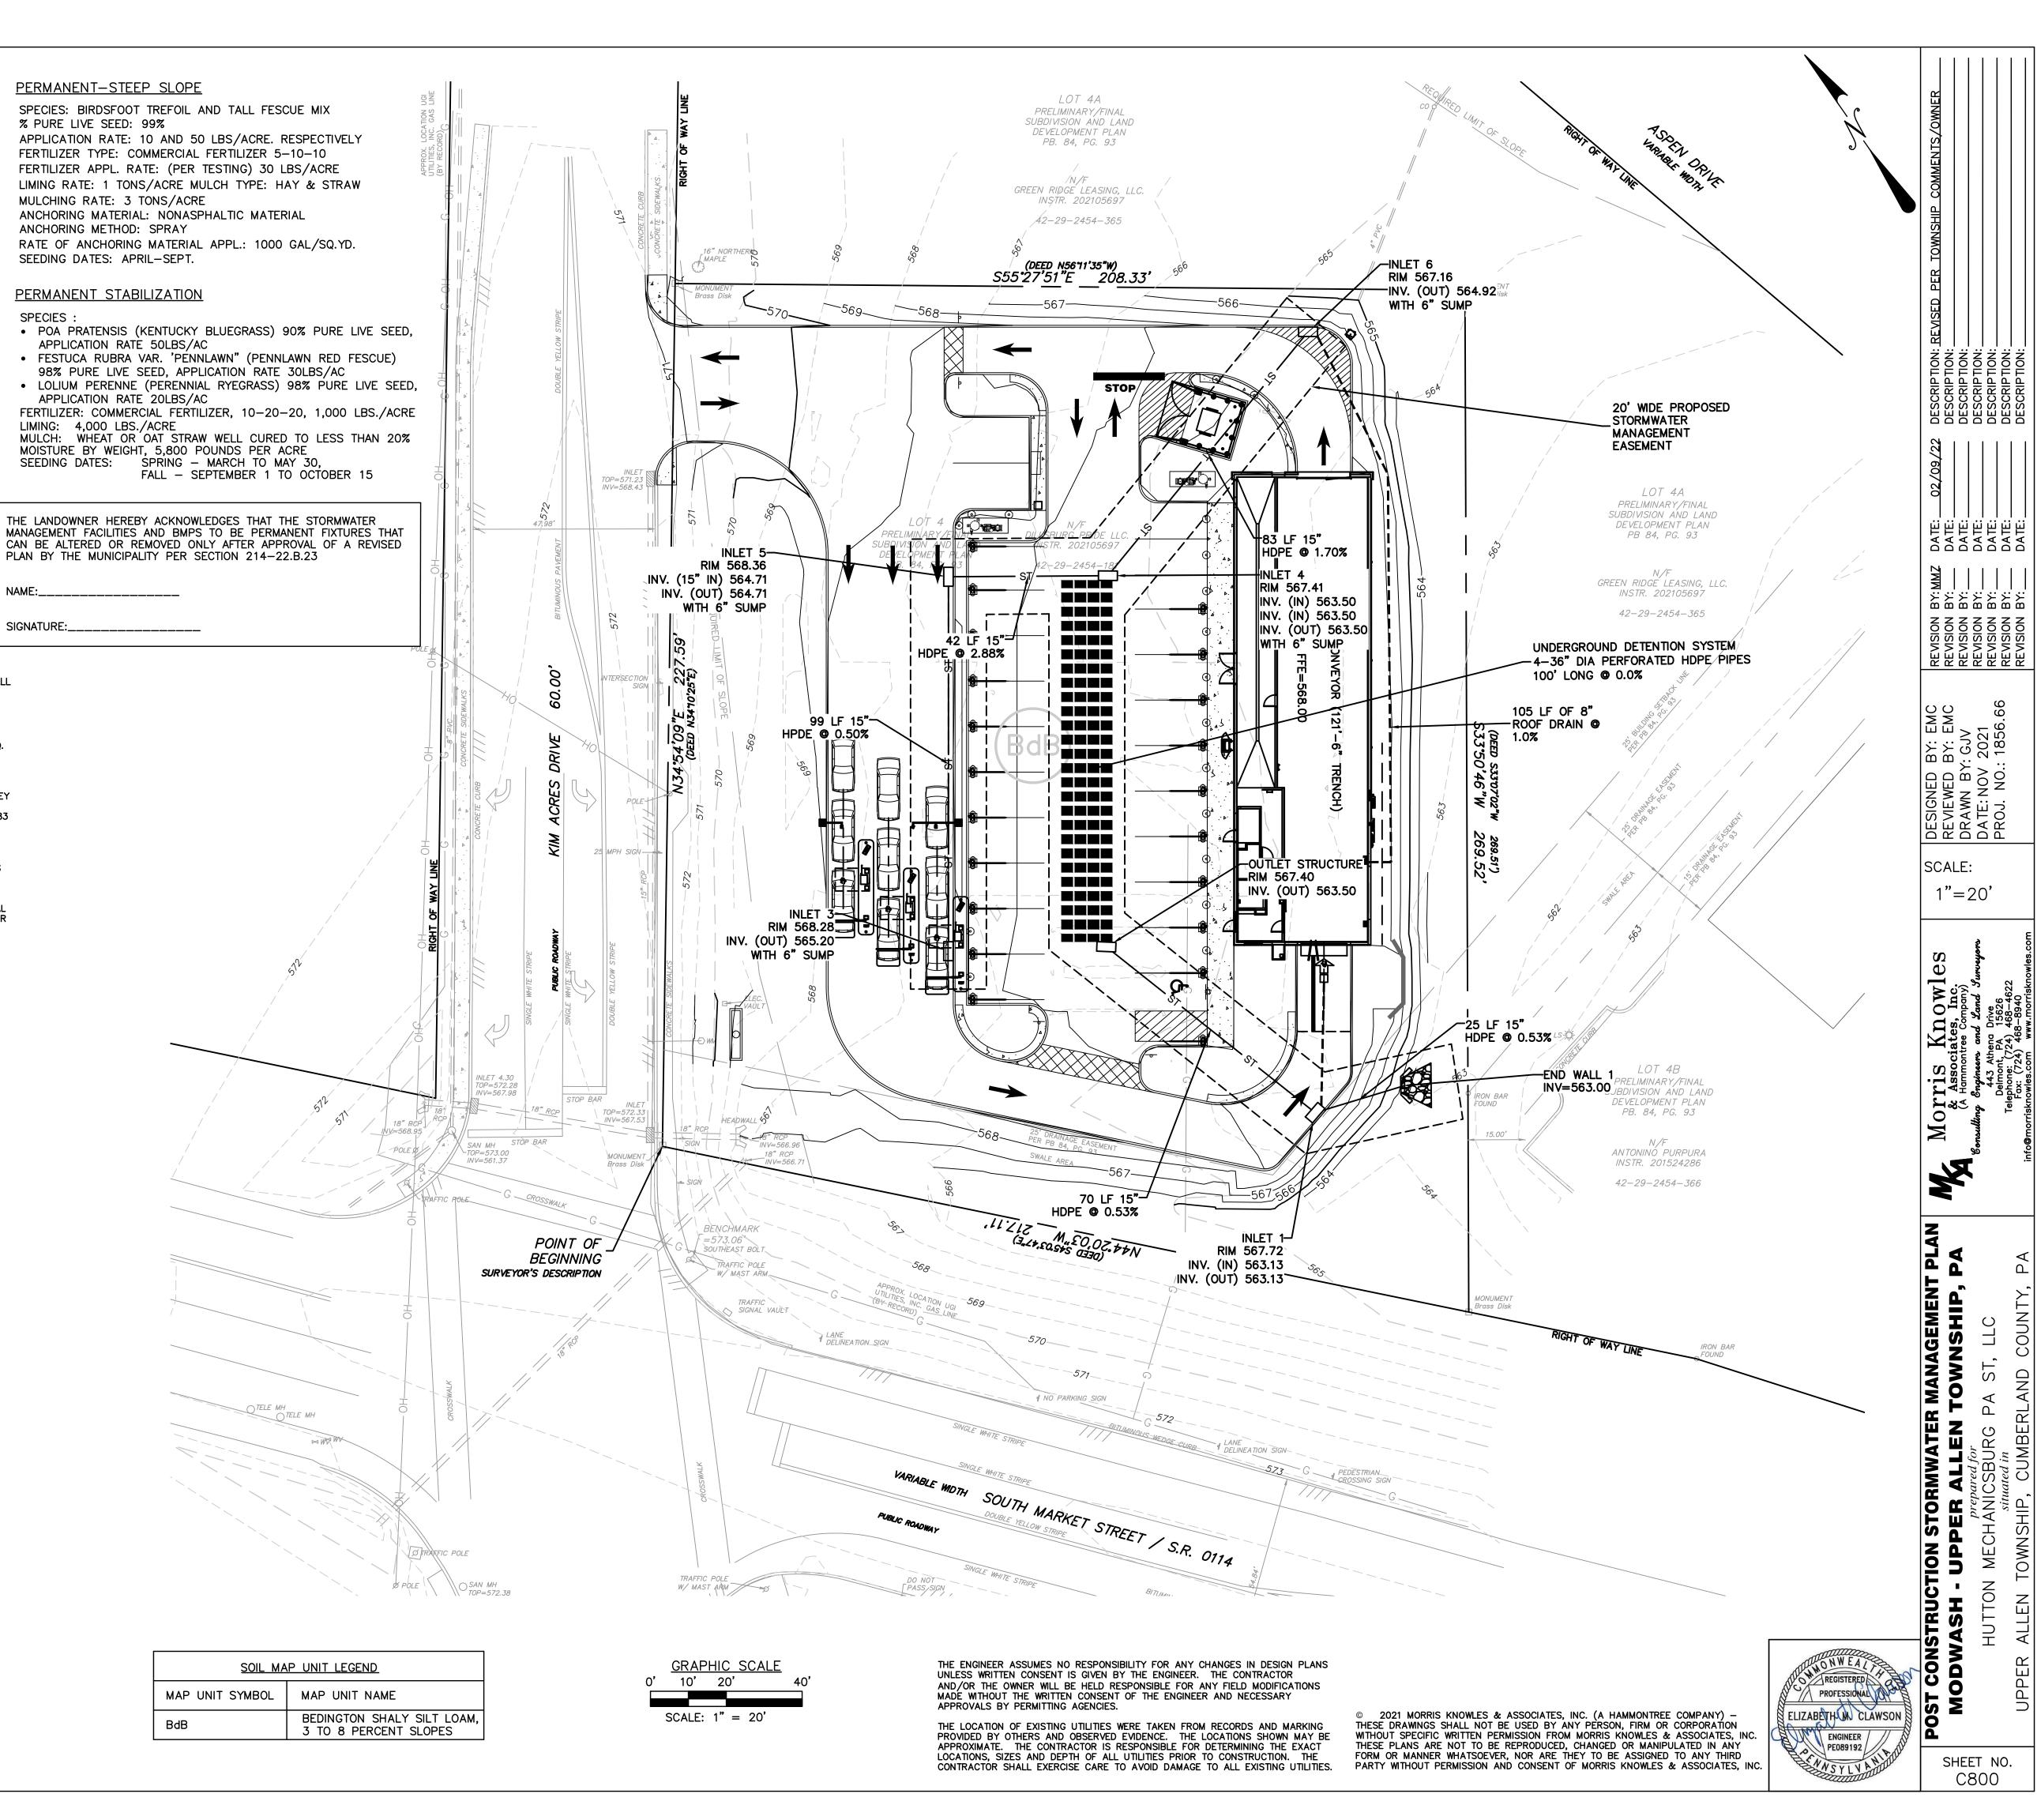


<u>ug detention profile - Sta. -0+20 to Sta. 1+20</u> HORIZ SCALE: 1"=20'


VERT SCALE: 1"=4'

ITEM	QTY	ALT. QTY	PART#	DESCRIPTION	STAN.	VENDOR	NOTE	N
1	2		3652AN	36".DOUBLE MANIFOLD TEE	STAN	ADS	SEE DETAIL	IN.
2	2		3698AN	36".MANIFOLD 90 DEG BEND	STAN	ADS	SEE DETAIL	
3	12 STICKS	236 LF	36850020IB	36".N12 HWY.STIB.SOLID.20'	STAN	ADS	AS SHOWN	
4	7 STICKS	119 LF	36850020IB	36".N12 HWY.STIB.SOLID.20'	STAN	ADS	FIELD CUT	•
5	8		3661AA	36".SPLIT COUPLER.(50/PALLET)	STAN	ADS	NOT SHOWN	ĺ
6	2 ROLLS	742 SY	0601TG	601.15' X 300'.(500 SY).(NTPEP SCAN) (20% OVERAGE)	STAN	ADS	SEE DETAIL	•
7	2		BY OTHERS	CONCRETE STRUCTURES	NA	BY OTHERS	AS SHOWN	•
8	9998 CF	371 CY	NA	EXCAVATION	NA	NA	NOT SHOWN	ĺ

THE SITE DESIGN ENGINEER MUST REVIEW ELEVATIONS AND IF NECESSARY ADJUST GRADING TO ENSURE THE PIPE COVER REQUIREMENTS ARE MET. STUB SIZES AND INVERTS TO BE VERIFIED BY THE SITE DESIGN ENGINEER PRIOR TO FABRICATION. ADS RISERS ARE FABRICATED 36" (900 mm) FROM TOP OF PIPE TO TOP OF RISER DUE TO SHIPPING LIMITATIONS. ADDITIONAL PIPE AND COUPLERS CAN BE USED TO EXTEND THE RISERS TO GRADE.

LAYOUT SHOWN DOES NOT INCLUDE ADDITIONAL PIPE & MANIFOLD NEEDED FOR PROPER PIPE INSERTION INTO STRUCTURES. NOT FOR CONSTRUCTION: THIS LAYOUT IS FOR DIMENSIONAL PURPOSES ONLY TO PROVE CONCEPT & THE REQUIRED STORAGE

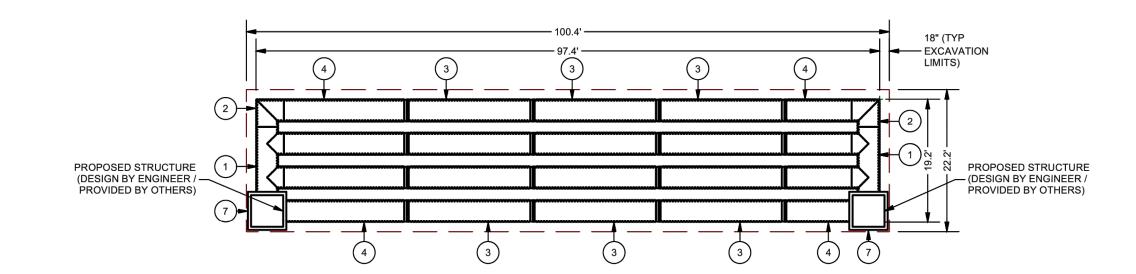

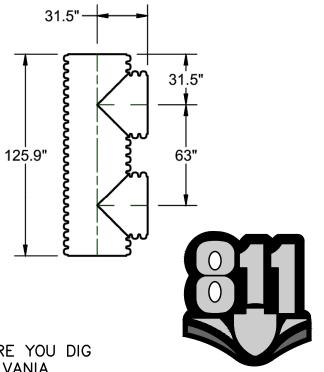

CALL BEFORE YOU DIG IN PENNSYLVANIA 1-800-242-1776 DESIGN SN: 20211762062


Know what's below Call before you dig

THE GENERAL CONTRACTOR SHALL NOTIFY ALL UTILITY COMPANIES INVOLVED IN THE SITE NO MORE TEN DAYS AND NO LESS THAN THREE DAYS IN ADVANCE OF EXCAVATION (PA ACT 287 OF 1974 AMENDED BY ACT 50 OF 2018). PA STATE LAW REQUIRES 3 WORKING DAYS NOTICE

THE ENGINEER ASSUMES NO RESPONSIBILITY FOR ANY CHANGES IN DESIGN PLANS UNLESS WRITTEN CONSENT IS GIVEN BY THE ENGINEER. THE CONTRACTOR AND/OR THE OWNER WILL BE HELD RESPONSIBLE FOR ANY FIELD MODIFICATIONS MADE WITHOUT THE WRITTEN CONSENT OF THE ENGINEER AND NECESSARY APPROVALS BY PERMITTING AGENCIES.


THE LOCATION OF EXISTING UTILITIES WERE TAKEN FROM RECORDS AND MARKING PROVIDED BY OTHERS AND OBSERVED EVIDENCE. THE LOCATIONS SHOWN MAY BE APPROXIMATE. THE CONTRACTOR IS RESPONSIBLE FOR DETERMINING THE EXACT LOCATIONS, SIZES AND DEPTH OF ALL UTILITIES PRIOR TO CONSTRUCTION. THE CONTRACTOR SHALL EXERCISE CARE TO AVOID DAMAGE TO ALL EXISTING UTILITIES.

© 2021 MORRIS KNOWLES & ASSOCIATES, INC. (A HAMMONTREE COMPANY) -THESE DRAWINGS SHALL NOT BE USED BY ANY PERSON, FIRM OR CORPORATION WITHOUT SPECIFIC WRITTEN PERMISSION FROM MORRIS KNOWLES & ASSOCIATES, INC. THESE PLANS ARE NOT TO BE REPRODUCED, CHANGED OR MANIPULATED IN ANY FORM OR MANNER WHATSOEVER, NOR ARE THEY TO BE ASSIGNED TO ANY THIRD PARTY WITHOUT PERMISSION AND CONSENT OF MORRIS KNOWLES & ASSOCIATES, INC.

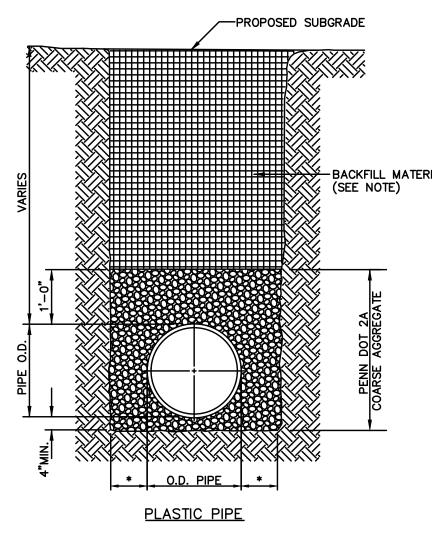

STORM SEWER STANDARD TRENCHING

O.D. - OUTSIDE PIPE DIAMETER

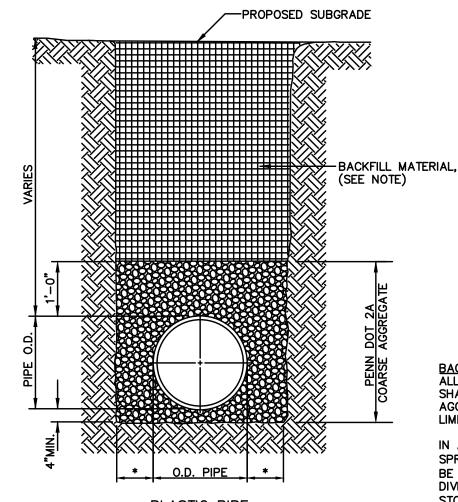

ALL STREET, SIDEWALK AND PARKING AREA CROSSINGS SHALL BE BACKFILLED TO SUBGRADE WITH AASHTO #57 AGGREGATE, GRAVEL OR STONE FOR SEWERS AND 2A LIMESTONE FOR ALL OTHER UTILITIES.

IN ALL OTHER TRENCH AREAS; BACKFILL FROM THE SPRINGLINE TO (1) ONE FOOT ABOVE THE TOP OF PIPE, TO BE SELECTED MATERIAL (SELECTED MATERIAL IS FINELY DIVIDED MATERIAL FREE OF DEBRIS, ORGANIC MATERIAL AND STONES.), TAMPED IN (4) FOUR INCH LAYERS; THEN THE REMAINING BACKFILL FROM THE TRENCH MAY BE PLACED. IF UNSUITABLE BACKFILL IS DETERMINED TO BE PRESENT BY THE OWNER REPRESENTATIVE, IMPORTED BACKFILL WILL * 12" IN PENNDOT R.O.W. - 8" MIN. IN ALL OTHER CONDITIONS

15" HDPE

(OUT)

DAY BAY


SCALE:

N/A

\%<

36" PERF.

HDPE

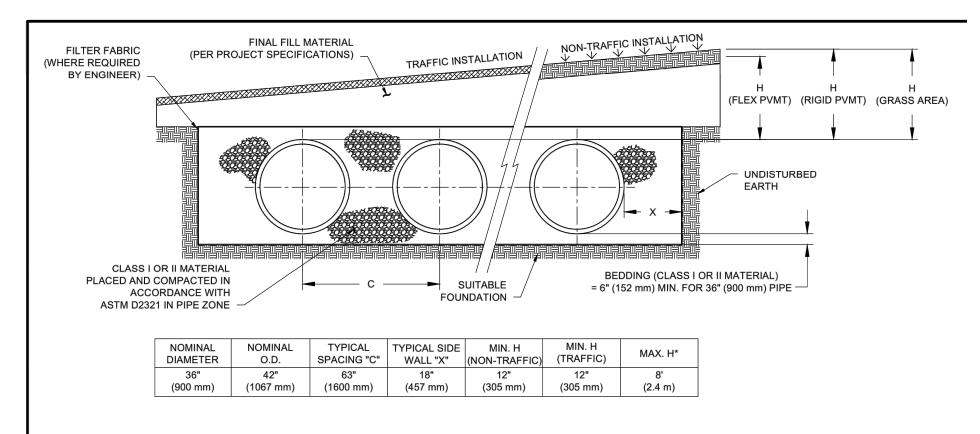


* MAXIMUM FILL HEIGHTS OVER MANIFOLD FITTINGS. CONTACT MANUFACTURER'S REPRESENTATIVE FOR INSTALLATION CONSIDERATIONS WHEN COVER EXCEEDS 8 FT (2.4 m).

NOTES:

- 1. ALL REFERENCES TO CLASS I OR II MATERIAL ARE PER ASTM D2321 "STANDARD PRACTICE FOR UNDERGROUND INSTALLATION OF THERMOPLASTIC PIPE FOR SEWERS AND OTHER GRAVITY FLOW APPLICATIONS", LATEST EDITION.
- 2. ALL RETENTION AND DETENTION SYSTEMS SHALL BE INSTALLED IN ACCORDANCE WITH ASTM D2321, LATEST EDITION AND THE MANUFACTURER'S PUBLISHED INSTALLATION GUIDELINES.
- 3. MEASURES SHOULD BE TAKEN TO PREVENT THE MIGRATION OF NATIVE FINES INTO THE BACKFILL MATERIAL, WHEN REQUIRED. SEE
- 4. FILTER FABRIC: A GEOTEXTILE FABRIC MAY BE USED AS SPECIFIED BY THE ENGINEER TO PREVENT THE MIGRATION OF FINES FROM THE NATIVE SOIL INTO THE SELECT BACKFILL MATERIAL.
- 5. FOUNDATION: WHERE THE TRENCH BOTTOM IS UNSTABLE. THE CONTRACTOR SHALL EXCAVATE TO A DEPTH REQUIRED BY THE ENGINEER AND REPLACE WITH SUITABLE MATERIAL AS SPECIFIED BY THE ENGINEER. AS AN ALTERNATIVE AND AT THE DISCRETION OF THE DESIGN ENGINEER, THE TRENCH BOTTOM MAY BE STABILIZED
- 6. BEDDING: SUITABLE MATERIAL SHALL BE CLASS I OR II. THE CONTRACTOR SHALL PROVIDE DOCUMENTATION FOR MATERIAL SPECIFICATION TO ENGINEER. UNLESS OTHERWISE NOTED BY THE ENGINEER, MINIMUM BEDDING THICKNESS SHALL BE 4" (102 mm) FOR
- 7. INITIAL BACKFILL: SUITABLE MATERIAL SHALL BE CLASS I OR II IN THE PIPE ZONE EXTENDING NOT LESS THAN 6" (152 mm) ABOVE CROWN OF PIPE. THE CONTRACTOR SHALL PROVIDE DOCUMENTATION FOR MATERIAL SPECIFICATION TO ENGINEER. MATERIAL SHALL BE INSTALLED AS REQUIRED IN ASTM D2321, LATEST EDITION.

4"-24" (100-600 mm); 6" (152 mm) FOR 30-60" (750-900 mm).

8. COVER: MINIMUM COVER OVER ALL RETENTION/DETENTION SYSTEMS IN NON-TRAFFIC APPLICATIONS (GRASS OR LANDSCAPE AREAS) IS 12" (305 mm) FROM TOP OF PIPE TO GROUND SURFACE. ADDITIONAL COVER MAY BE REQUIRED TO PREVENT FLOATATION. FOR TRAFFIC APPLICATIONS, MINIMUM COVER IS 12" (305 mm) UP TO 36" (900 mm) DIAMETER PIPE AND 24" (610 mm) OF COVER FOR 42-60" (1050-1500 mm) DIAMETER PIPE, MEASURED FROM TOP OF PIPE TO BOTTOM OF FLEXIBLE PAVEMENT OR TO TOP OF RIGID PAVEMENT. MAXIMUM FILL HEIGHT LIMITED TO 8 FT (2.4 m) OVER FITTINGS FOR STANDARD INSTALLATIONS. CONTACT A SALES REPRESENTATIVE WHEN MAXIMUM FILL HEIGHTS EXCEED 8 FT (2.4 m) FOR INSTALLATION CONSIDERATIONS.

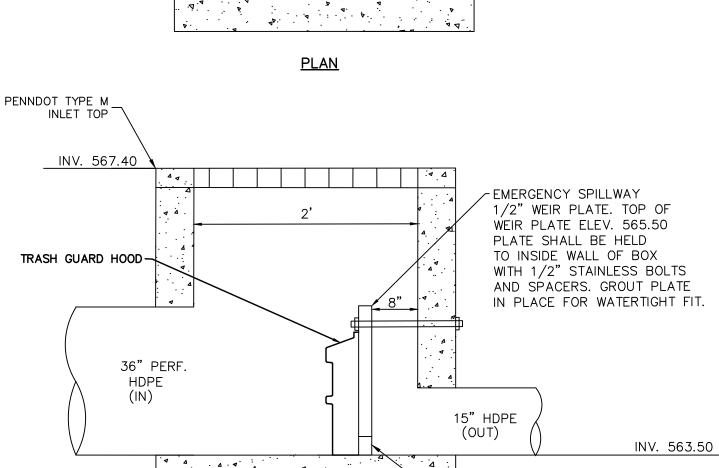

UNDERGROUND DETENTION POND OUTLET STRUCTURE NO SCALE

<u>SECTION</u>

MAINTENANCE PROGRAM:

USING A GEOTEXTILE MATERIAL.


DURING CONSTRUCTION, ALL FILTER FABRIC FENCE AND EROSION AND SEDIMENTATION CONTROL FACILITIES WILL BE INSPECTED, AS NEEDED, TO INSURE ALL SYSTEMS ARE FUNCTIONING PROPERLY. FILTER FABRIC FENCE WILL BE REPLACED, AS NEEDED. THE CONTRACTOR WILL BE RESPONSIBLE FOR REPLACEMENT AND REPAIR.

DURING CONSTRUCTION, ALL CONSTRUCTION ENTRANCES TO THE SITE WILL BE PROTECTED BY GRAVEL BEDS. THE INFILTRATION SYSTEMS WILL BE INSPECTED PERIODICALLY DURING CONSTRUCTION AND AGAIN UPON PROJECT COMPLETION FOR PROPER OPERATION. THE SYSTEM WILL THEREAFTER BE INSPECTED EACH MONTH BY THE OWNER. IF THE SYSTEM SHOWS ANY SIGNS OF FAILURE OR IMPROPER OPERATION AT ANY TIME, THE OWNER WILL REPLACE AND/OR REPAIR THE AFFECTED AREAS.

INSPECTION OF THE STORMWATER MANAGEMENT SYSTEM WILL INCLUDE:

INSPECTION SHALL BE DONE OF THE ENTIRE STORMWATER MANAGEMENT FACILITY AFTER EVERY STORM EVENT EXCEEDING ONE INCH OF RAINFALL AND AT LEAST ONCE EVERY THREE MONTHS. THIS INSPECTION WILL INCLUDE:

- 1. INSPECTION OF INLET BOXES AND STORM SEWERS FOR ACCUMULATIONS OF DEBRIS AND/OR SEDIMENT.
- 2. MAINTENANCE OF THE FACILITIES SHALL INCLUDE VEGETATION CUTTING AND/OR REMOVAL ALONG WITH ROUTINE MAINTENANCE AS DETERMINED BY THE ENGINEER.
- 3. THE OWNER SHALL CONTACT THE ENGINEER IF ANY SIGNS OF FAILURE HAVE BEEN FOUND DURING THE MONTHLY INSPECTION.
- 4. A RECORD OF THE INSPECTIONS SHOULD BE KEPT BY THE OWNER FOR REVIEW BY THE MUNICIPALITY.

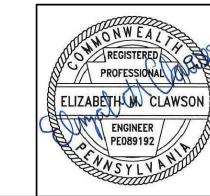

SHEET NO.